NEW HOME:


MARTINEZ, CA 94553

APN:367-140-017

RESIDENCE 5 CASA DE CAMPO,



A1.11 COVER SHEET A2.11 SITE PLAN ENLARGED SITE PLAN A2.12 LEGENDS AND KEYNOTES PROPOSED FLOOR PLAN -LOWER LEVEL 1 PROPOSED FLOOR PLAN -MAIN LEVEL 2 PROPOSED FLOOR PLAN -ADU LEVEL 3 SCHEDULES PROPOSED ROOF PLAN PERSPECTIVE VIEWS ELEVATIONS EXTERIOR ELEVATIONS EXTERIOR SECTIONS DETAILS UTILITY KEYNOTES AND LEGEND UTILITY PLAN-LEVEL 1 UTILITY PLAN-LEVEL 2 UTILITY PLAN-LEVEL 3

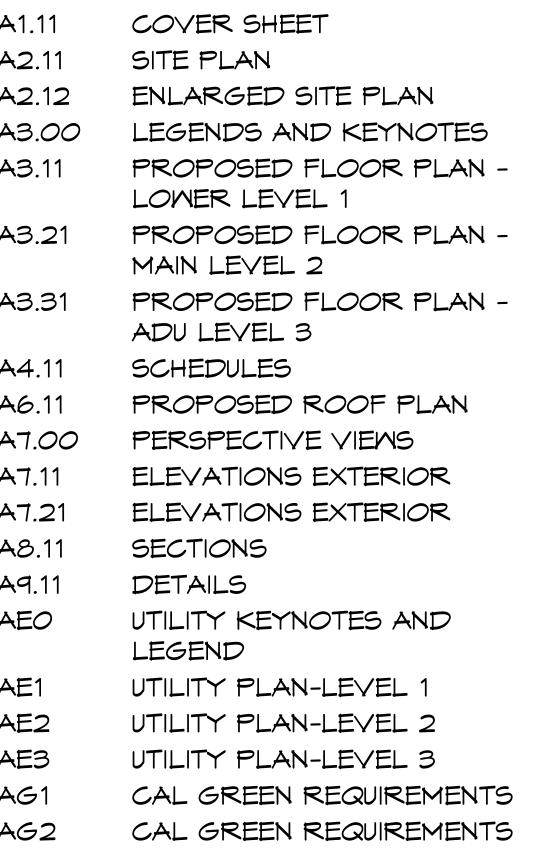

SHEET INDEX

TITLES:

COVER SHEET

ISSUES:

PROPOSED 875 S.F.

745 S.F.

1199 S.F.

1620 S.F 1530 S.F. 2946 S.F.

> PLAN CHECK PCO1 CONST. DOCUMENTS DESIGN DEVELOPMENT SCHEMATIC DESIGN 2021.09.30



GENERAL BUILDING NOTES

EXISTING SITE CONDITIONS:

_							
1.01	1.01 PRIOR TO CONTRACT APPROVAL, THE GENERAL ENGINEERING CONTRACTOR, GENERAL CONTRACTOR AND SUBCONTRACTORS SHALL VISIT THE PROJECT SITE, AND BY THEIR OWN INVESTIGATION, DETERMINE EXISTING SITE CONDITIONS AS TO THE QUANTITIES OF MATERIALS, LABOR HOURS, AND ANY OTHER COST ASSOCIATED WITH WORK THAT IS TO BE DONE UNDER THEIR CONTRACT AND AS REQUIRED TO PASS ALL BUILDING PERMIT INSPECTIONS. ALL MODIFICATIONS REQUIRED BY THE INSPECTION AUTHORITY SHALL BE MADE BY EACH SUBCONTRACTOR AT THEIR EXPENSE. PERMITS, LICENSES, INSPECTIONS AND FEES:	LDA	ADJACENT	GL	GLASS	SHMR	SHOWER
		ALUM	ALUMINUM	GYP	GYPSUM	SIM	SIMILAR
		ВМ	BEAM	Н	HIGH OR HEIGHT	SIMP	'SIMPSON'
		BOM	BOTTOM OF WALL	HB	HOSE BIBB	SLD	SLIDING
		BLKG	BLOCKING	JTS	JOIST	S&P	SHELF & POLE
_		BRD	BOARD	LAV	LAVATORY	STRUCT	STRUCTURAL
2.01	THE OWNER SHALL BE RESPONSIBLE FOR OBTAINING ALL REQUIRED PLAN REVIEW, PERMIT, LICENSE, AND INSPECTION APPROVALS. ALL FEES REQUIRED FOR APPROVAL SHALL BE PAID BY THE OWNER.	CC	CENTER TO CENTER	LB	POUND	Т	TREAD
		CL	CENTERLINE	LIN	LINEN	TEMP	TEMPERED
		CEM	CEMENT	LT	LIGHT	TOC	TOP OF CONCRETE
-	DATA AND MEASUREMENTS:		CERAMIC	MANF	MANUFACTURER	TOG	TOP OF GRADE
	DRAWING DATA CONTAINED HEREIN IS AS EXACT AS COULD BE DETERMINED WITHIN THE PROJECT DESIGNER'S DESIGN SCOPE OF SERVICES RENDERED. AS SUCH THE ABSOLUTE ACCURACY OF THE DESIGN DATA IS NOT GUARANTEED. THE GENERAL ENGINEERING CONTRACTOR, GENERAL CONTRACTOR AND SUBCONTRACTORS SHALL ENDEAVOR TO OBTAIN, VERIFY AND CONFIRM EXACT DESIGN DATA ON SITE AND SUITABLY ADAPT THE WORK TO CONFORM TO EXACT CONDITIONS ON SITE. THE CONTRACTOR SHALL REPORT ANY DESIGN DATA AMBIGUITIES OR DISCREPANCIES CONTAINED IN THE CONTRACT TO THE OWNER IN WRITING. ALL MODIFICATIONS REQUIRED TO ADAPT THE WORK SHALL BE MADE BY THE CONTRACTOR AT THE CONTRACTOR'S EXPENSE. DO NOT SCALE THE DRAWINGS. WRITTEN DIMENSIONS AND ACTUAL BUILDING MEASUREMENTS TAKE PRECEDENCE OVER SCALED DRAWING INFORMATION.	CJ	CONTROL JOINT	MAX	MAXIMUM	TOF	TOP OF FLOOR
		CLG	CEILING	MC	MEDICINE CABINET	TOP	TOP OF PAVEMENT
		CLR	CLEAR	MIN	MINIMUM	T05	TOP OF SLAB
		CLO	CLOSET	MTL	METAL	TOM	TOP OF WALL
		co	CLEANOUT	N	NORTH	TV	TELEVISION
		CONC	CONCRETE	0/	OVER	TYP	TYPICAL
		CONTIN	CONTINUOUS	00	ON CENTER	UCR	UNDER COUNTER REFRIG.
		DBL	DOUBLE	OFCI	OWNER FURNISHED	M	MEST
		DF	DOUGLAS FIR		CONTRACTOR INSTALLED W	M/	MITH
3.03	DIMENSIONS TO DOORS, WINDOWS, AND OPENINGS ARE NOMINAL WIDTHS. REFER TO THE MANUFACTURER FOR ACTUAL ROUGH OPENINGS, FACE OF STUD	DI	DRAIN INLET	PB	PUSH BUTTON	MC	MATER CLOSET
	TO FACE OF STUD. ALL DOORS NOT LOCATED BY DIMENSION ON PLAN OR DETAIL SHALL BE 3 INCHES FROM FACE OF STUD TO FACE OF NEAREST DOOR BUCK OR CENTERED ON ROOM.	DIA	DIAMETER	PH	PHONE	MD	MOOD
		DR	DOOR	PL	PLATE	MH	MATER HEATER
3.04	ALL WALL DIMENSIONS ARE ACTUAL WALL FINISH DIMENSIONS ARE NOT TAKEN INTO ACCOUNT AND ARE THE	DM	DISH WASHER	POC	POINT OF CONNECTION	MP	WATER PROOF
3.05	RESPONSIBILITY OF THE CONTRACTOR AND SUBCONTRACTORS TO DETERMINE PROPER CLEARANCES. INSTALL ALL EQUIPMENT AND MATERIALS IN ACCORDANCE WITH	E	EAST	PT	PRESSURE TREATED	MMM	MELDED WIRE MESH
		EL	ELEVATION	R	RISER		
3.03	MANUFACTURERS RECOMMENDATIONS UNLESS SPECIFICALLY OTHERWISE	EQ	EQUAL	REF	REFRIGERATOR		
	INDICATED OR WHERE LOCAL CODES OR REGULATIONS TAKE PRECEDENCE.	FF	FINISH FLOOR	REINF	REINFORCED		
_	SUBSTITUTIONS FOR SPECIFIED MATERIALS: SPECIFIC TRADE NAMES MENTIONED IN THE DRAWINGS ARE FOR THE PURPOSES OF ESTABLISHING MINIMUM STANDARDS OF QUALITY, STYLE OR TYPE, AND SHALL NOT BE CONSTRUED TO RESTRICT SUBSTITUTIONS. ALL SUBSTITUTIONS SHALL BE SUBMITTED TO AND APPROVED BY THE OWNER IN WRITING WITHIN A SUFFICIENT TIME FRAME AS NOT TO DELAY PROJECT	FIX	FIXTURE	RM	ROOM		
F T S		FLUOR	FLUORESCENT	RWD	REDWOOD		
		FP	FIRE PLACE	5	SOUTH		
		GA	GAUGE	SB	SET BACK		
	COMPLETION.	GFCI	GROUND FAULT INTERRUPTER	SF	SQUARE FOOT		

BUILDING SHEET ABBREVIATIONS

GALV GALVANIZED

AB ANCHOR BOLT

PROJECT LOCATION: APN:367-140-017 5 CASA DE CAMPO, MARTINEZ, CA 94553

PROJECT VICINITY MAP

PROJECT SCOPE NEW HOME

PROJECT TEAM

DESIGNER: USGL LAND,LLC

1200 Business Center Drive

STRUCTURAL ENGINEER:

TITLE 24 ENERGY CONSULTANT:

San Leandro,CA. 94577

mobile: 707-410-7102

TRUSS DESIGN:

CIVIL ENGINEER:

FIRE PROTECTION DESIGN:

david@usglland.com

TOTAL CONDITIONED AREA: LOT COVERAGE: % LOT COVERAGE: 6.7% (LOT SIZE: 67,736 S.F.)

PROJECT DATA

BUILDING AREA

2019 CBC, CRC, CEC, CMC, CPC, CEC, CEC (ENERGY CODE), CFC, & CGBC

R-3 (SINGLE FAMILY RESIDENCE)

TYPE V-B - THREE STORY FIRE-SPRINKLERED

APPLICABLE BUILDING CODE:

OCCUPANCY GROUP:

CONSTRUCTION TYPE

DECKS AND PATIO AT LEVEL-2


TOTAL UNCONDITIONED AREA:


RESIDENCE LEVEL-1

RESIDENCE LEVEL-2

RESIDENCE LEVEL-3



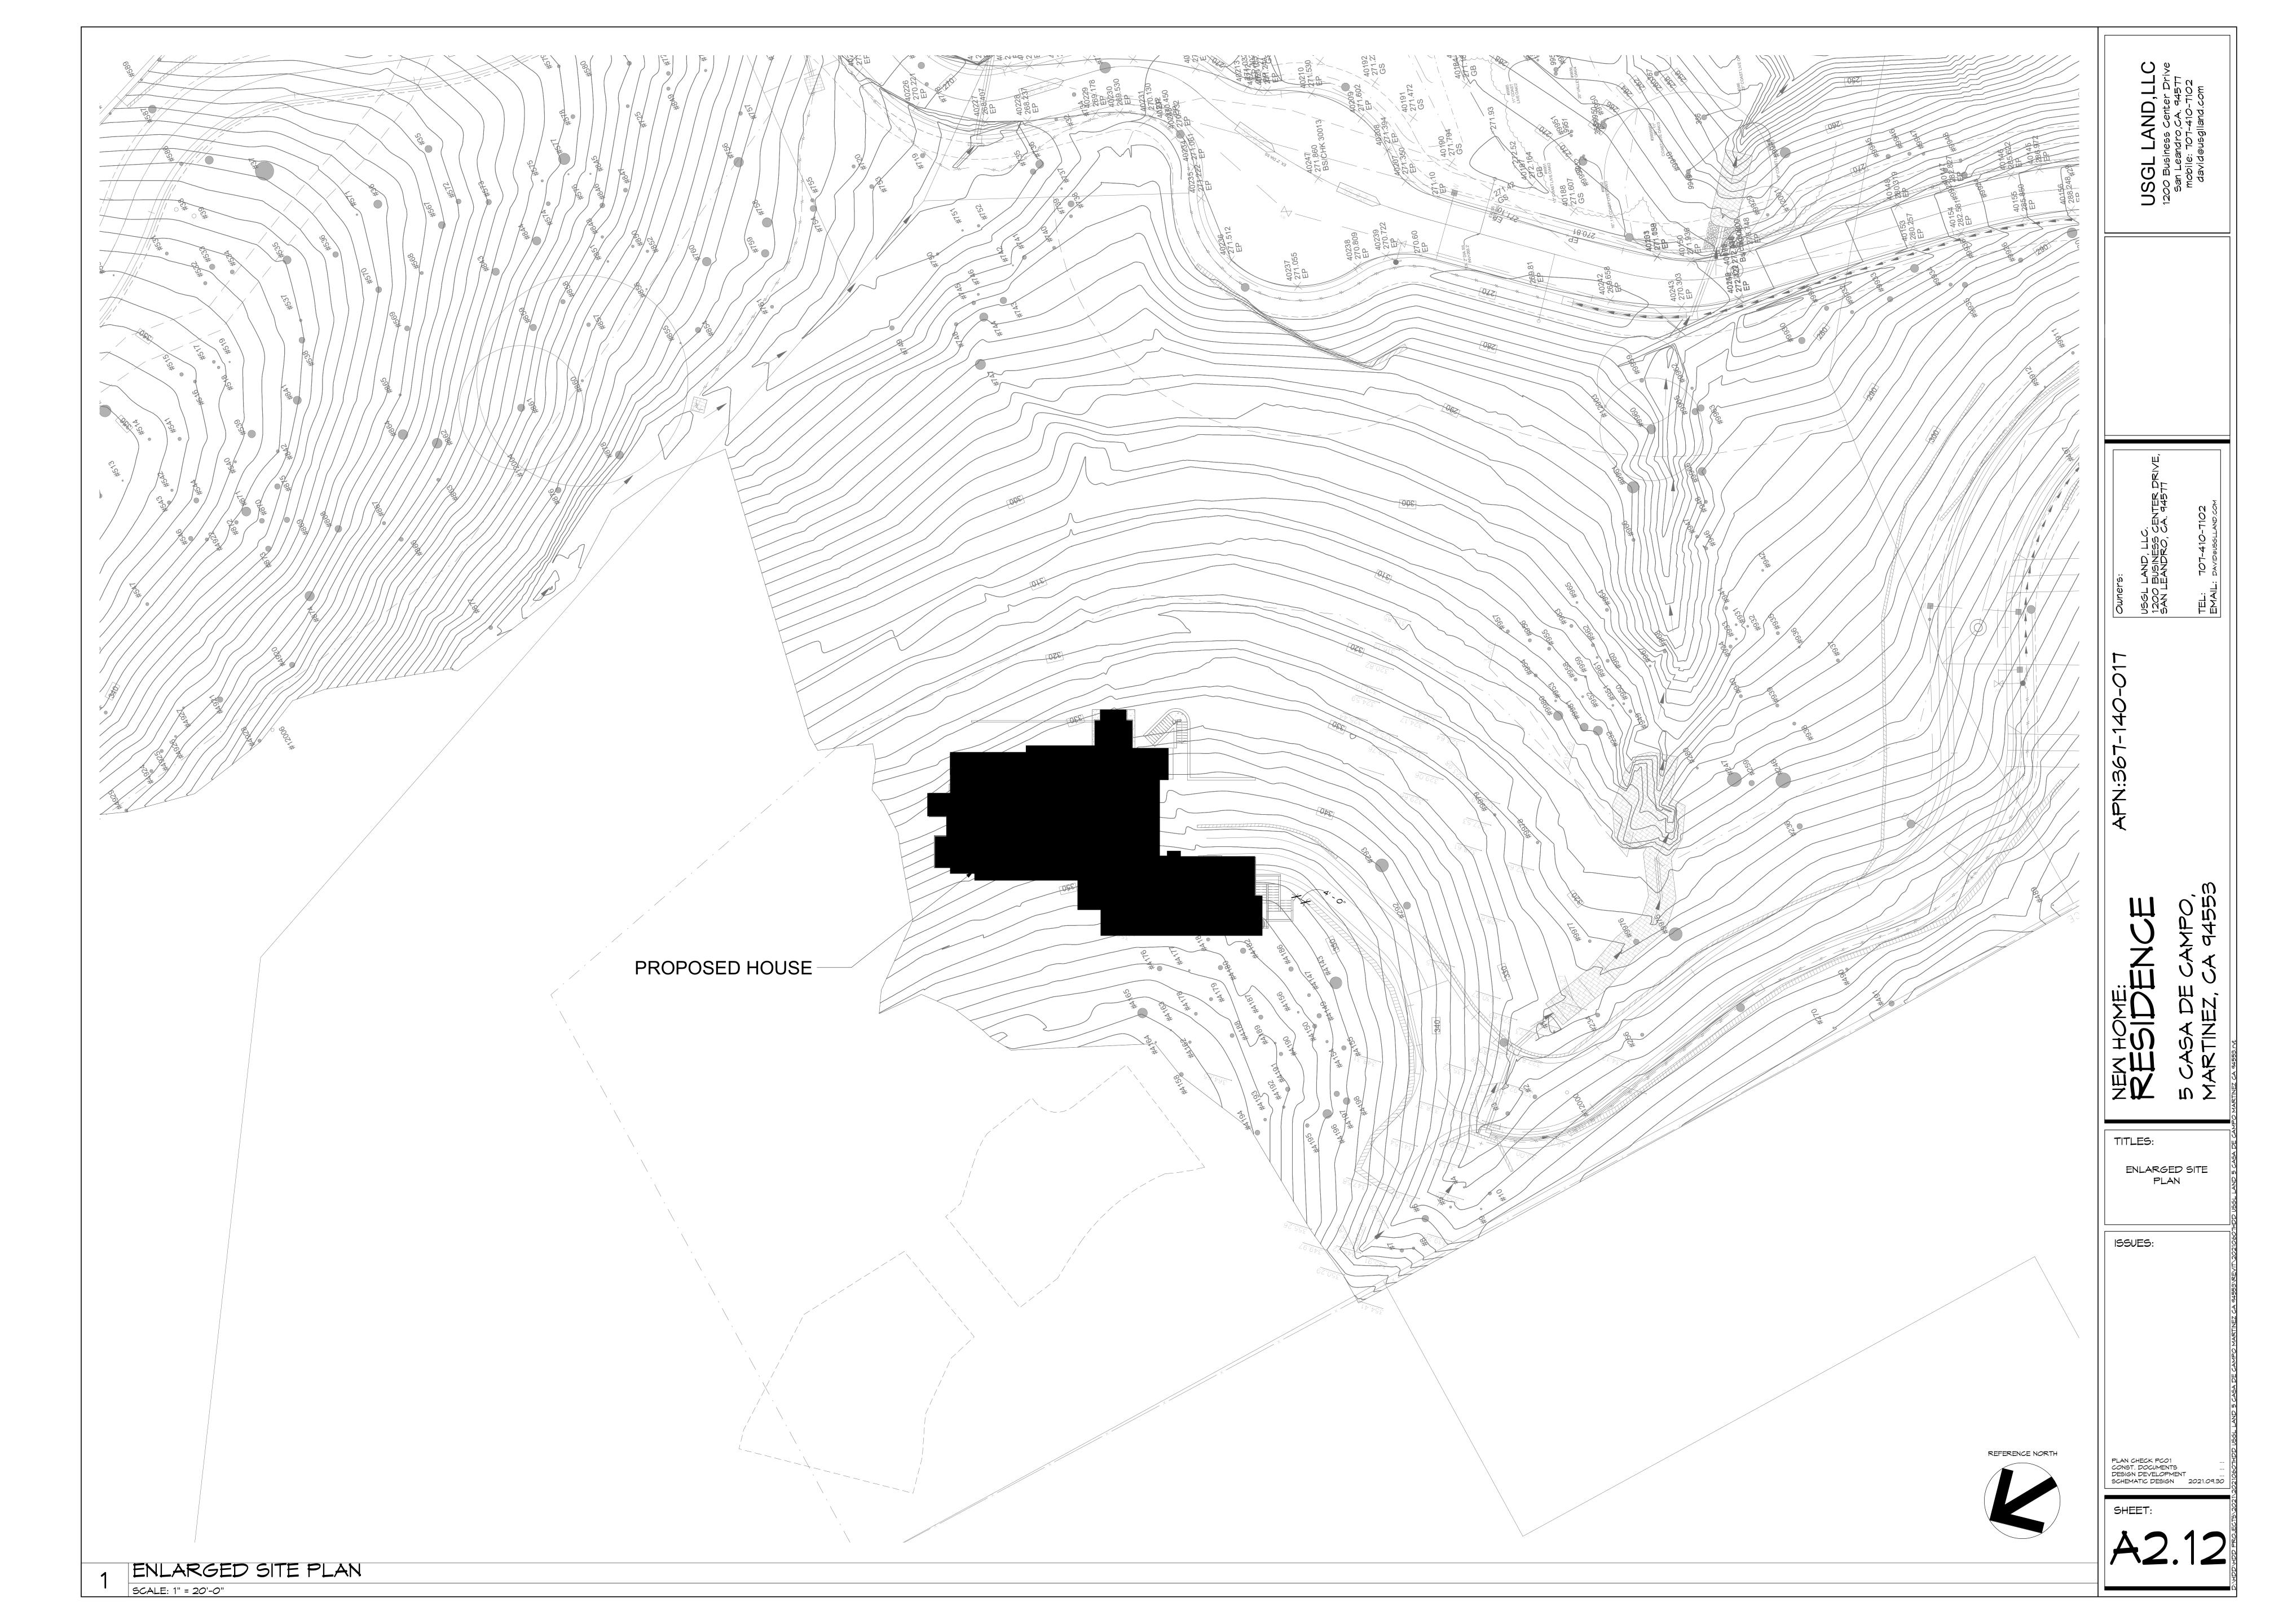

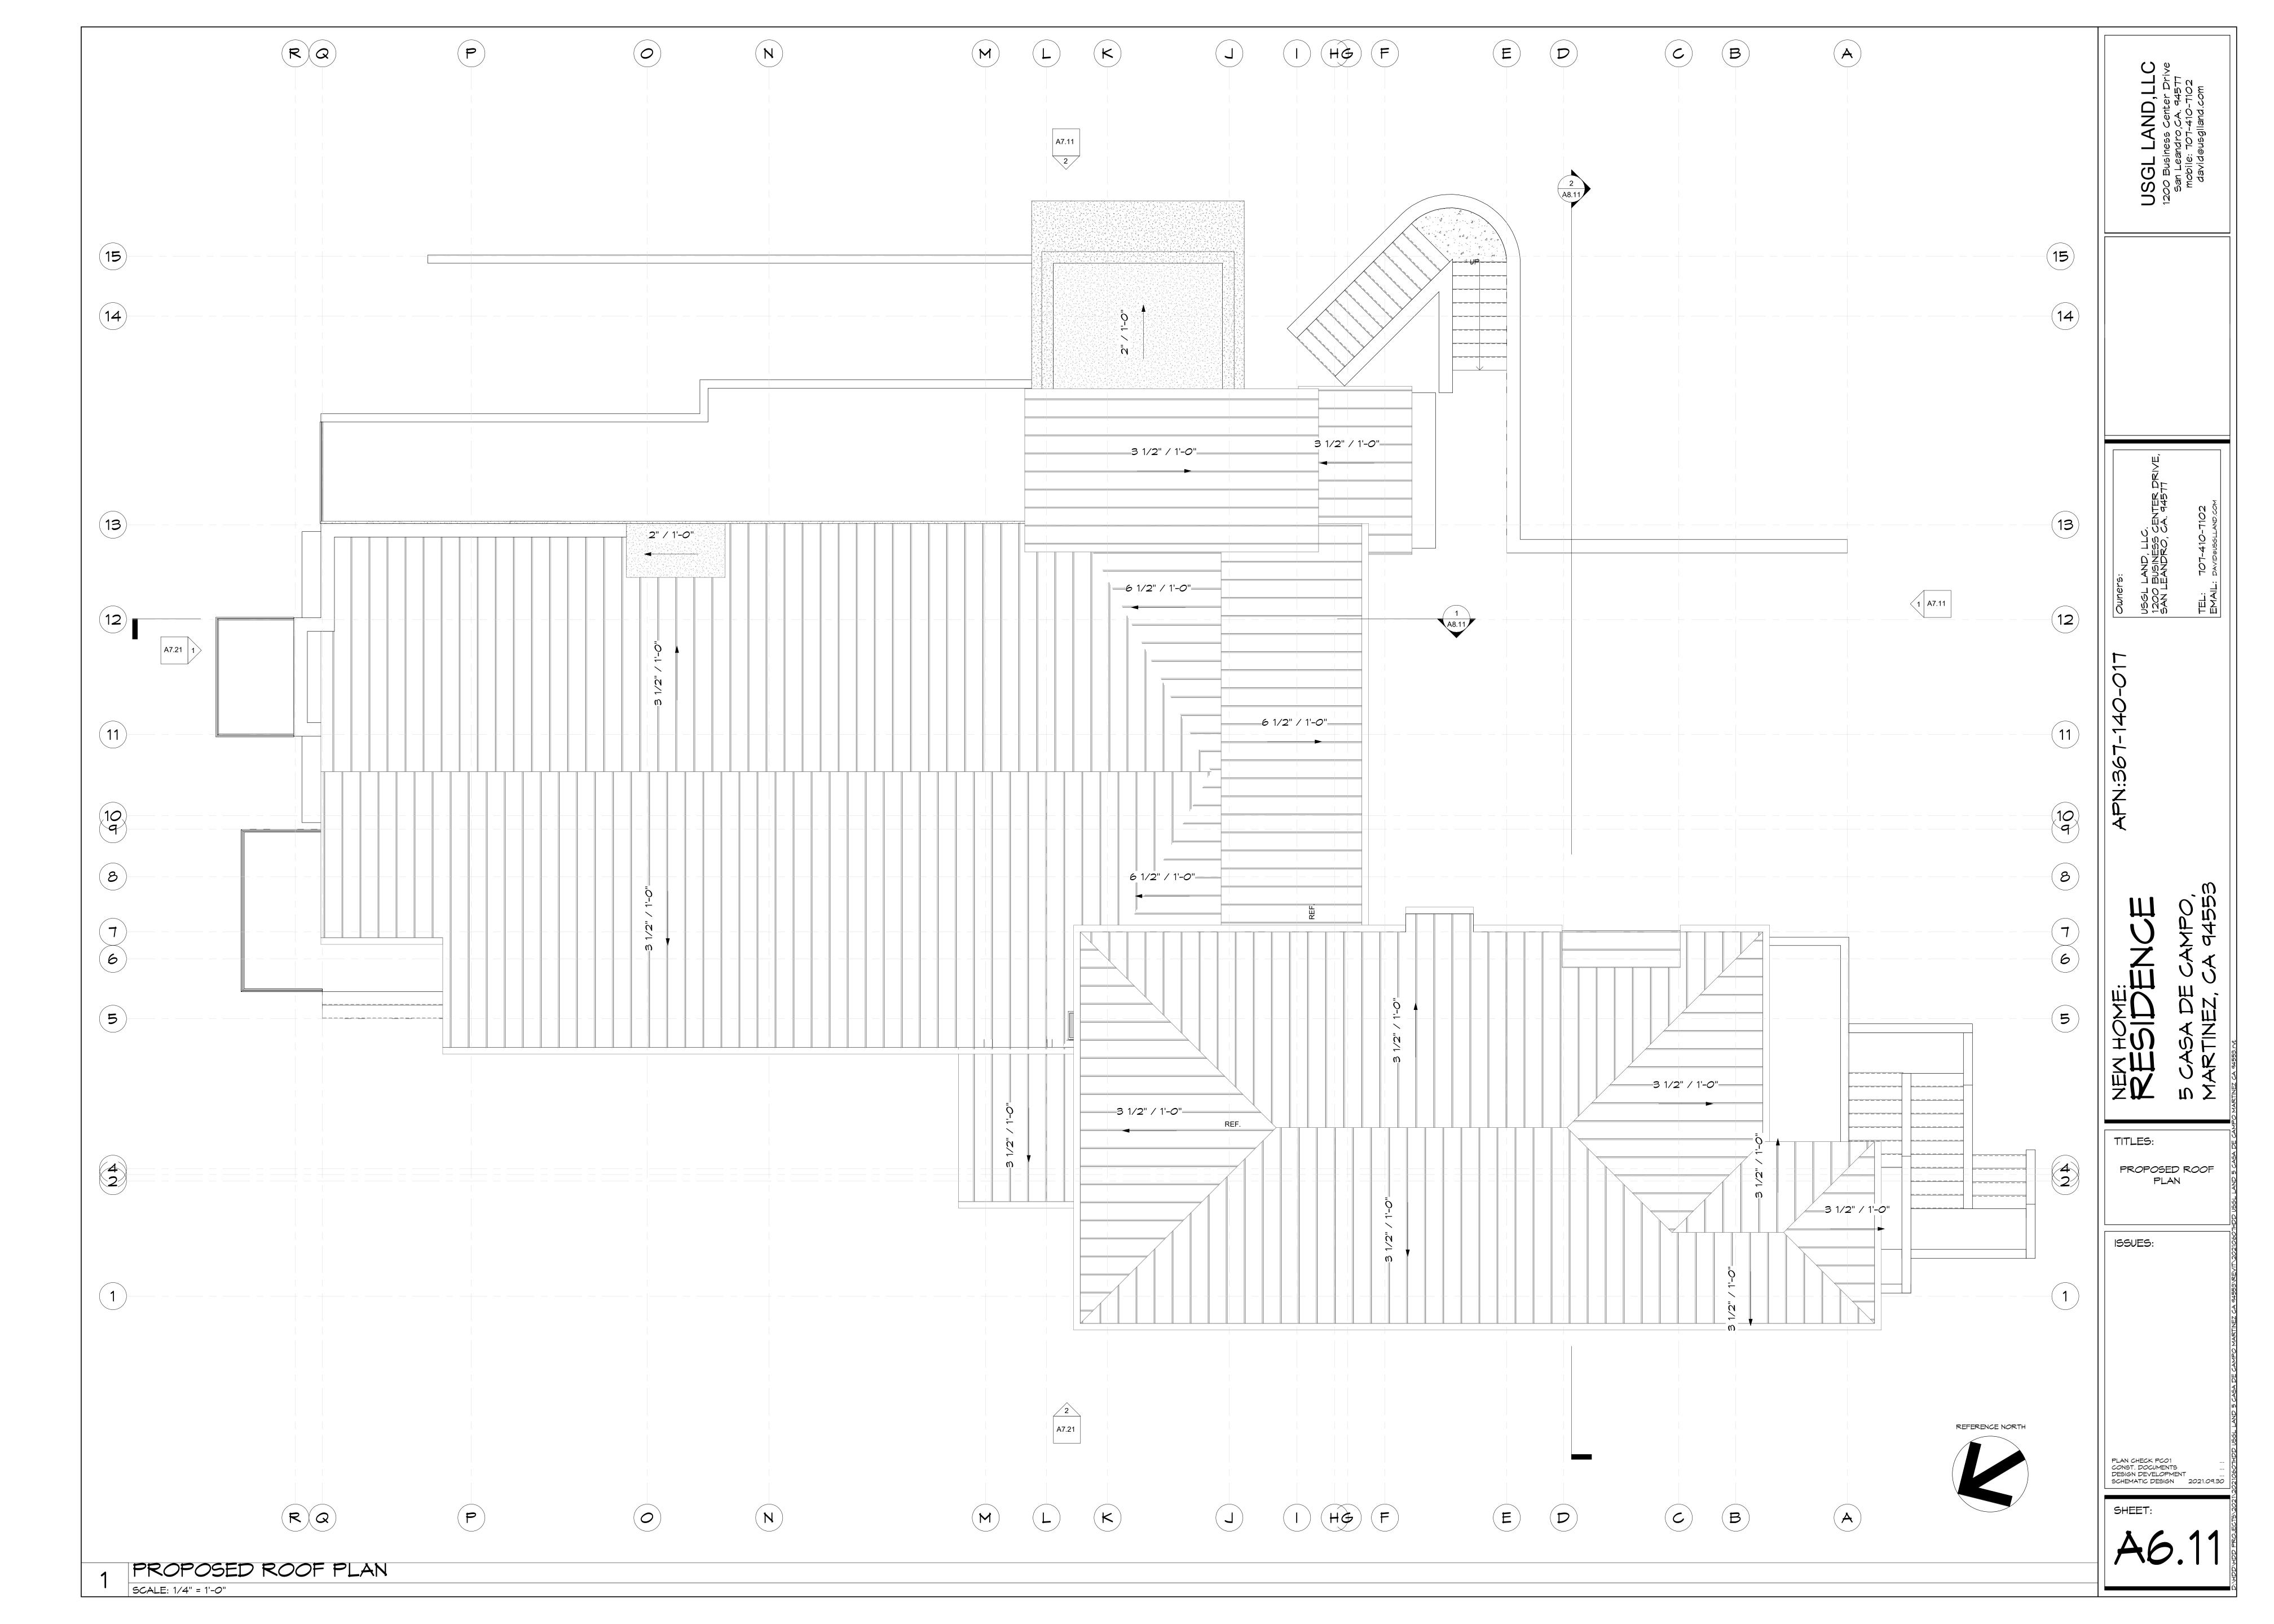



USGL LAND,LLC
1200 Business Center Drive
San Leandro,CA. 94577
mobile: 707-410-7102
david@usglland.com

NTUTTNPOTO CASA DE CAMPO, NARTINEZ CA 44553


TITLES:


PERSPECTIVE VIEWS


ISSUES:


PLAN CHECK PCO1 ...
CONST. DOCUMENTS ...
DESIGN DEVELOPMENT ...
SCHEMATIC DESIGN 2021.09.30


A7.00

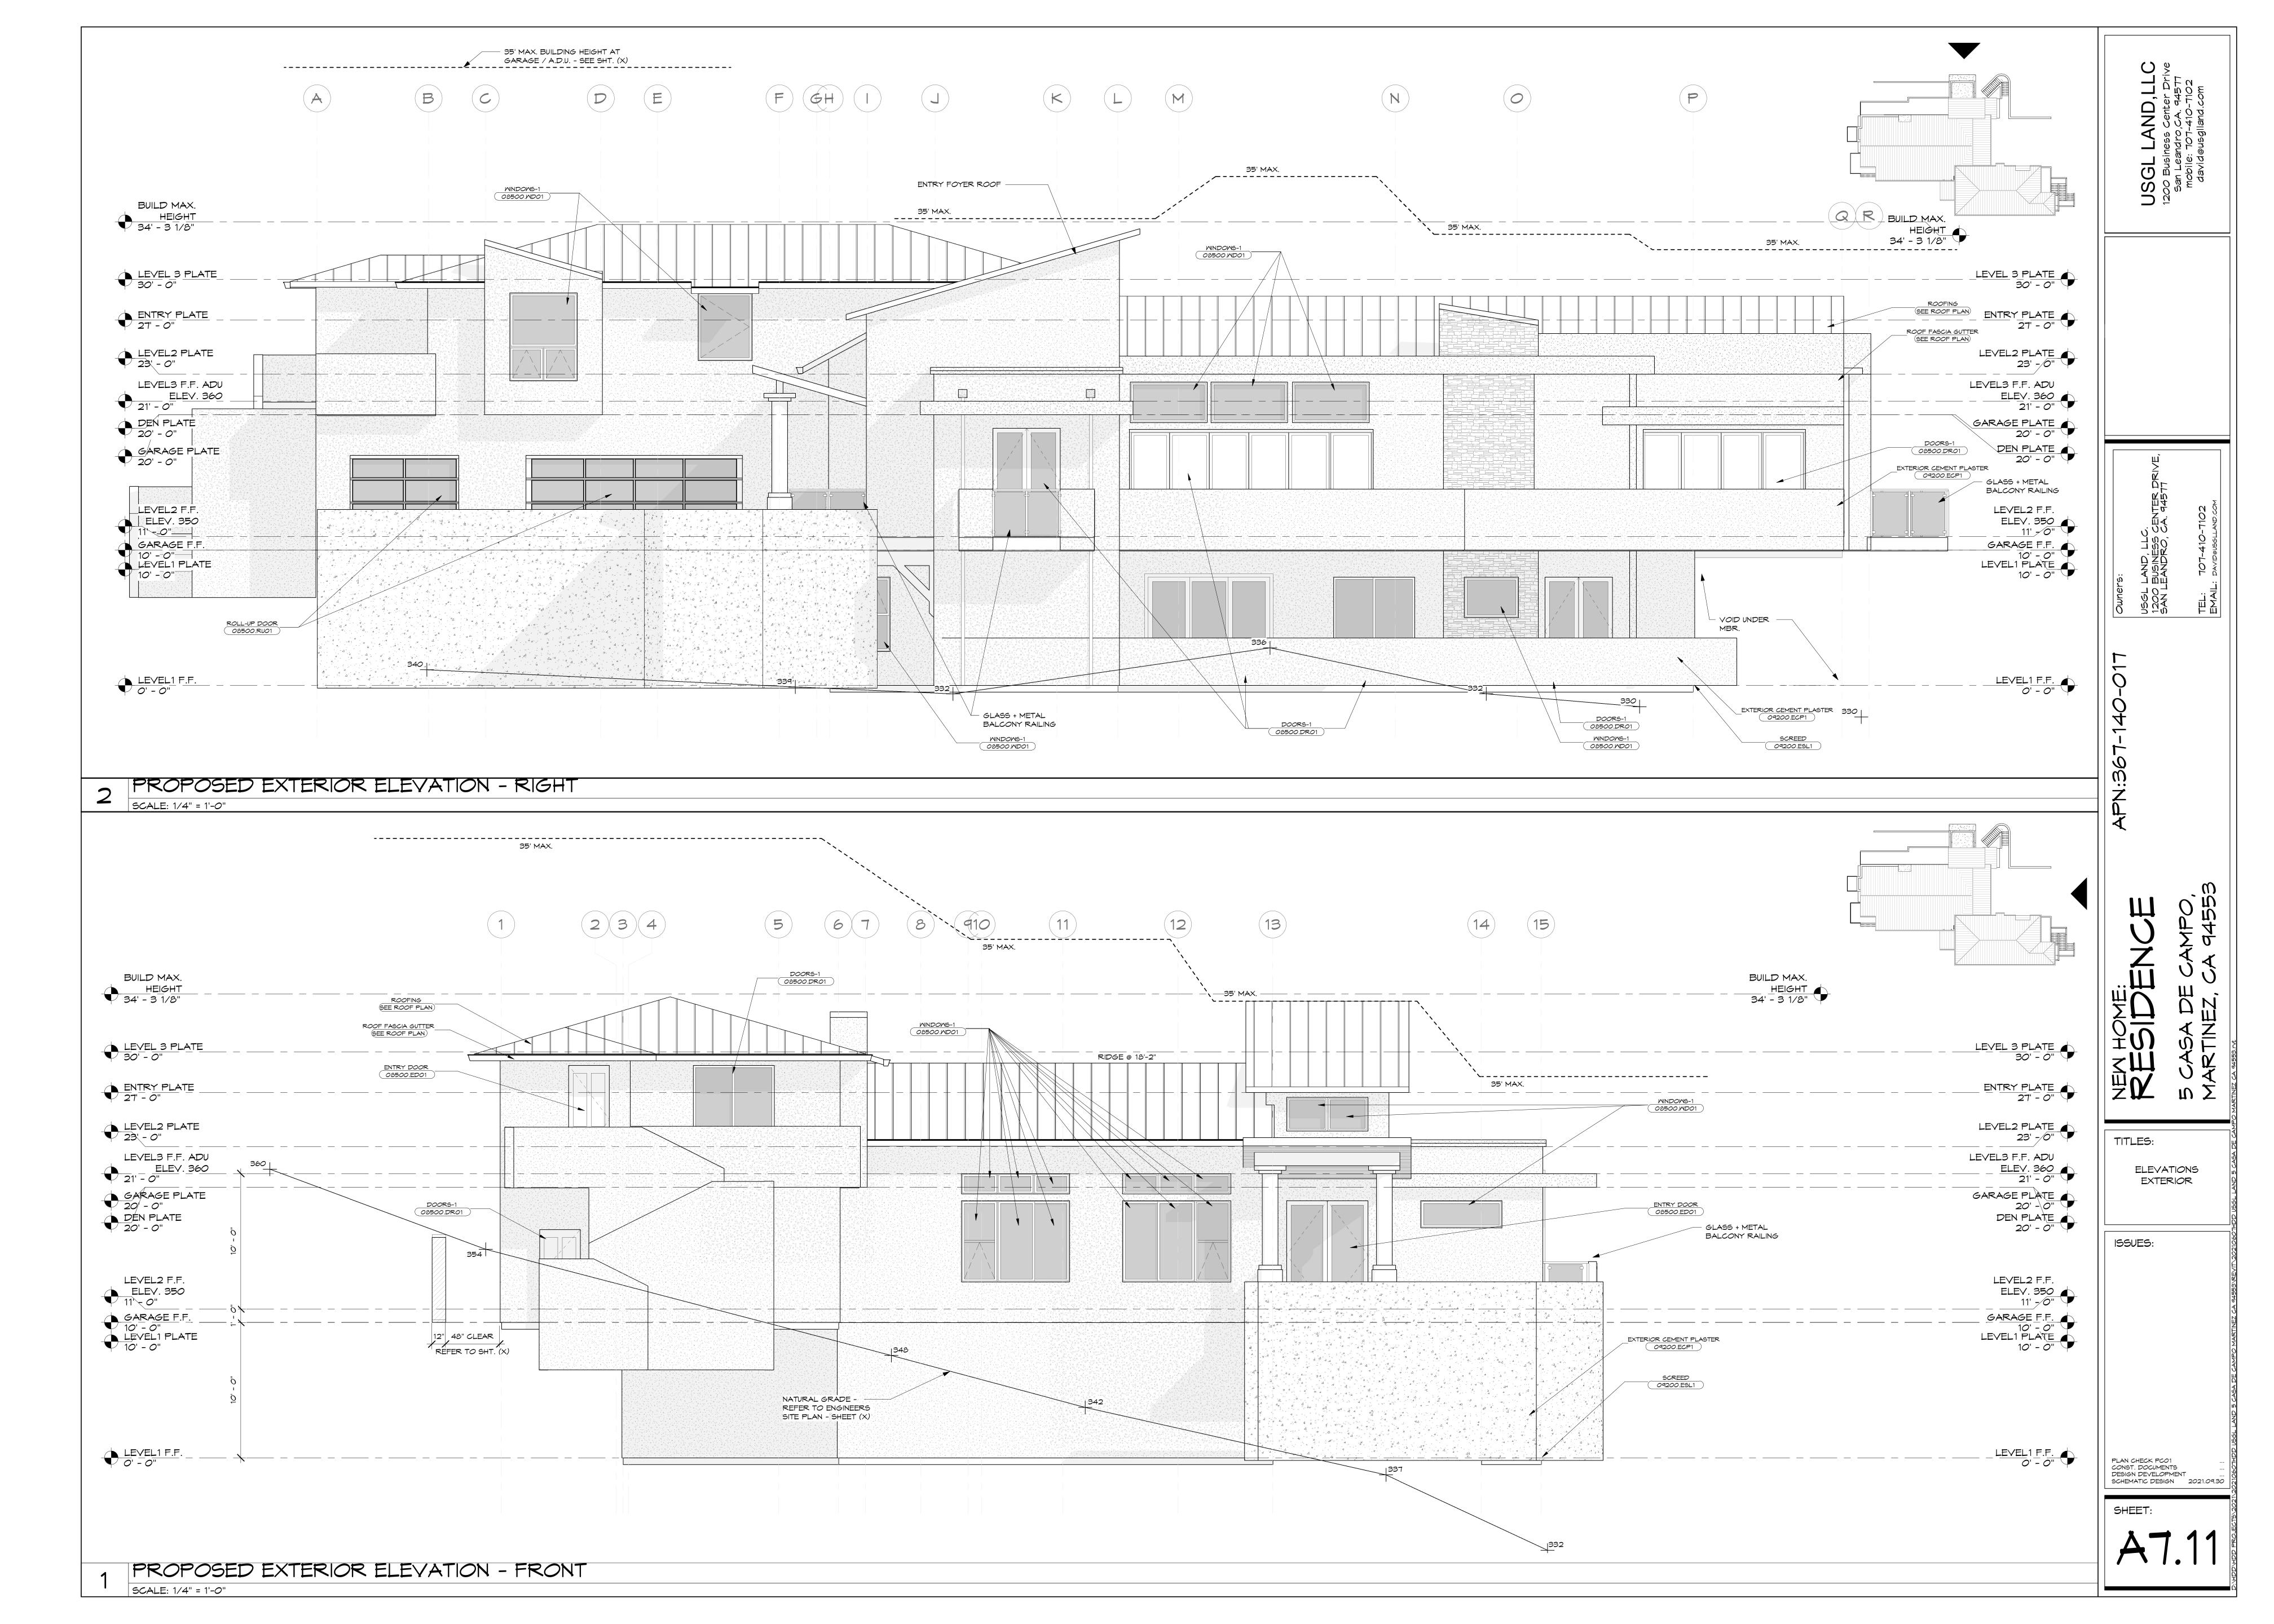

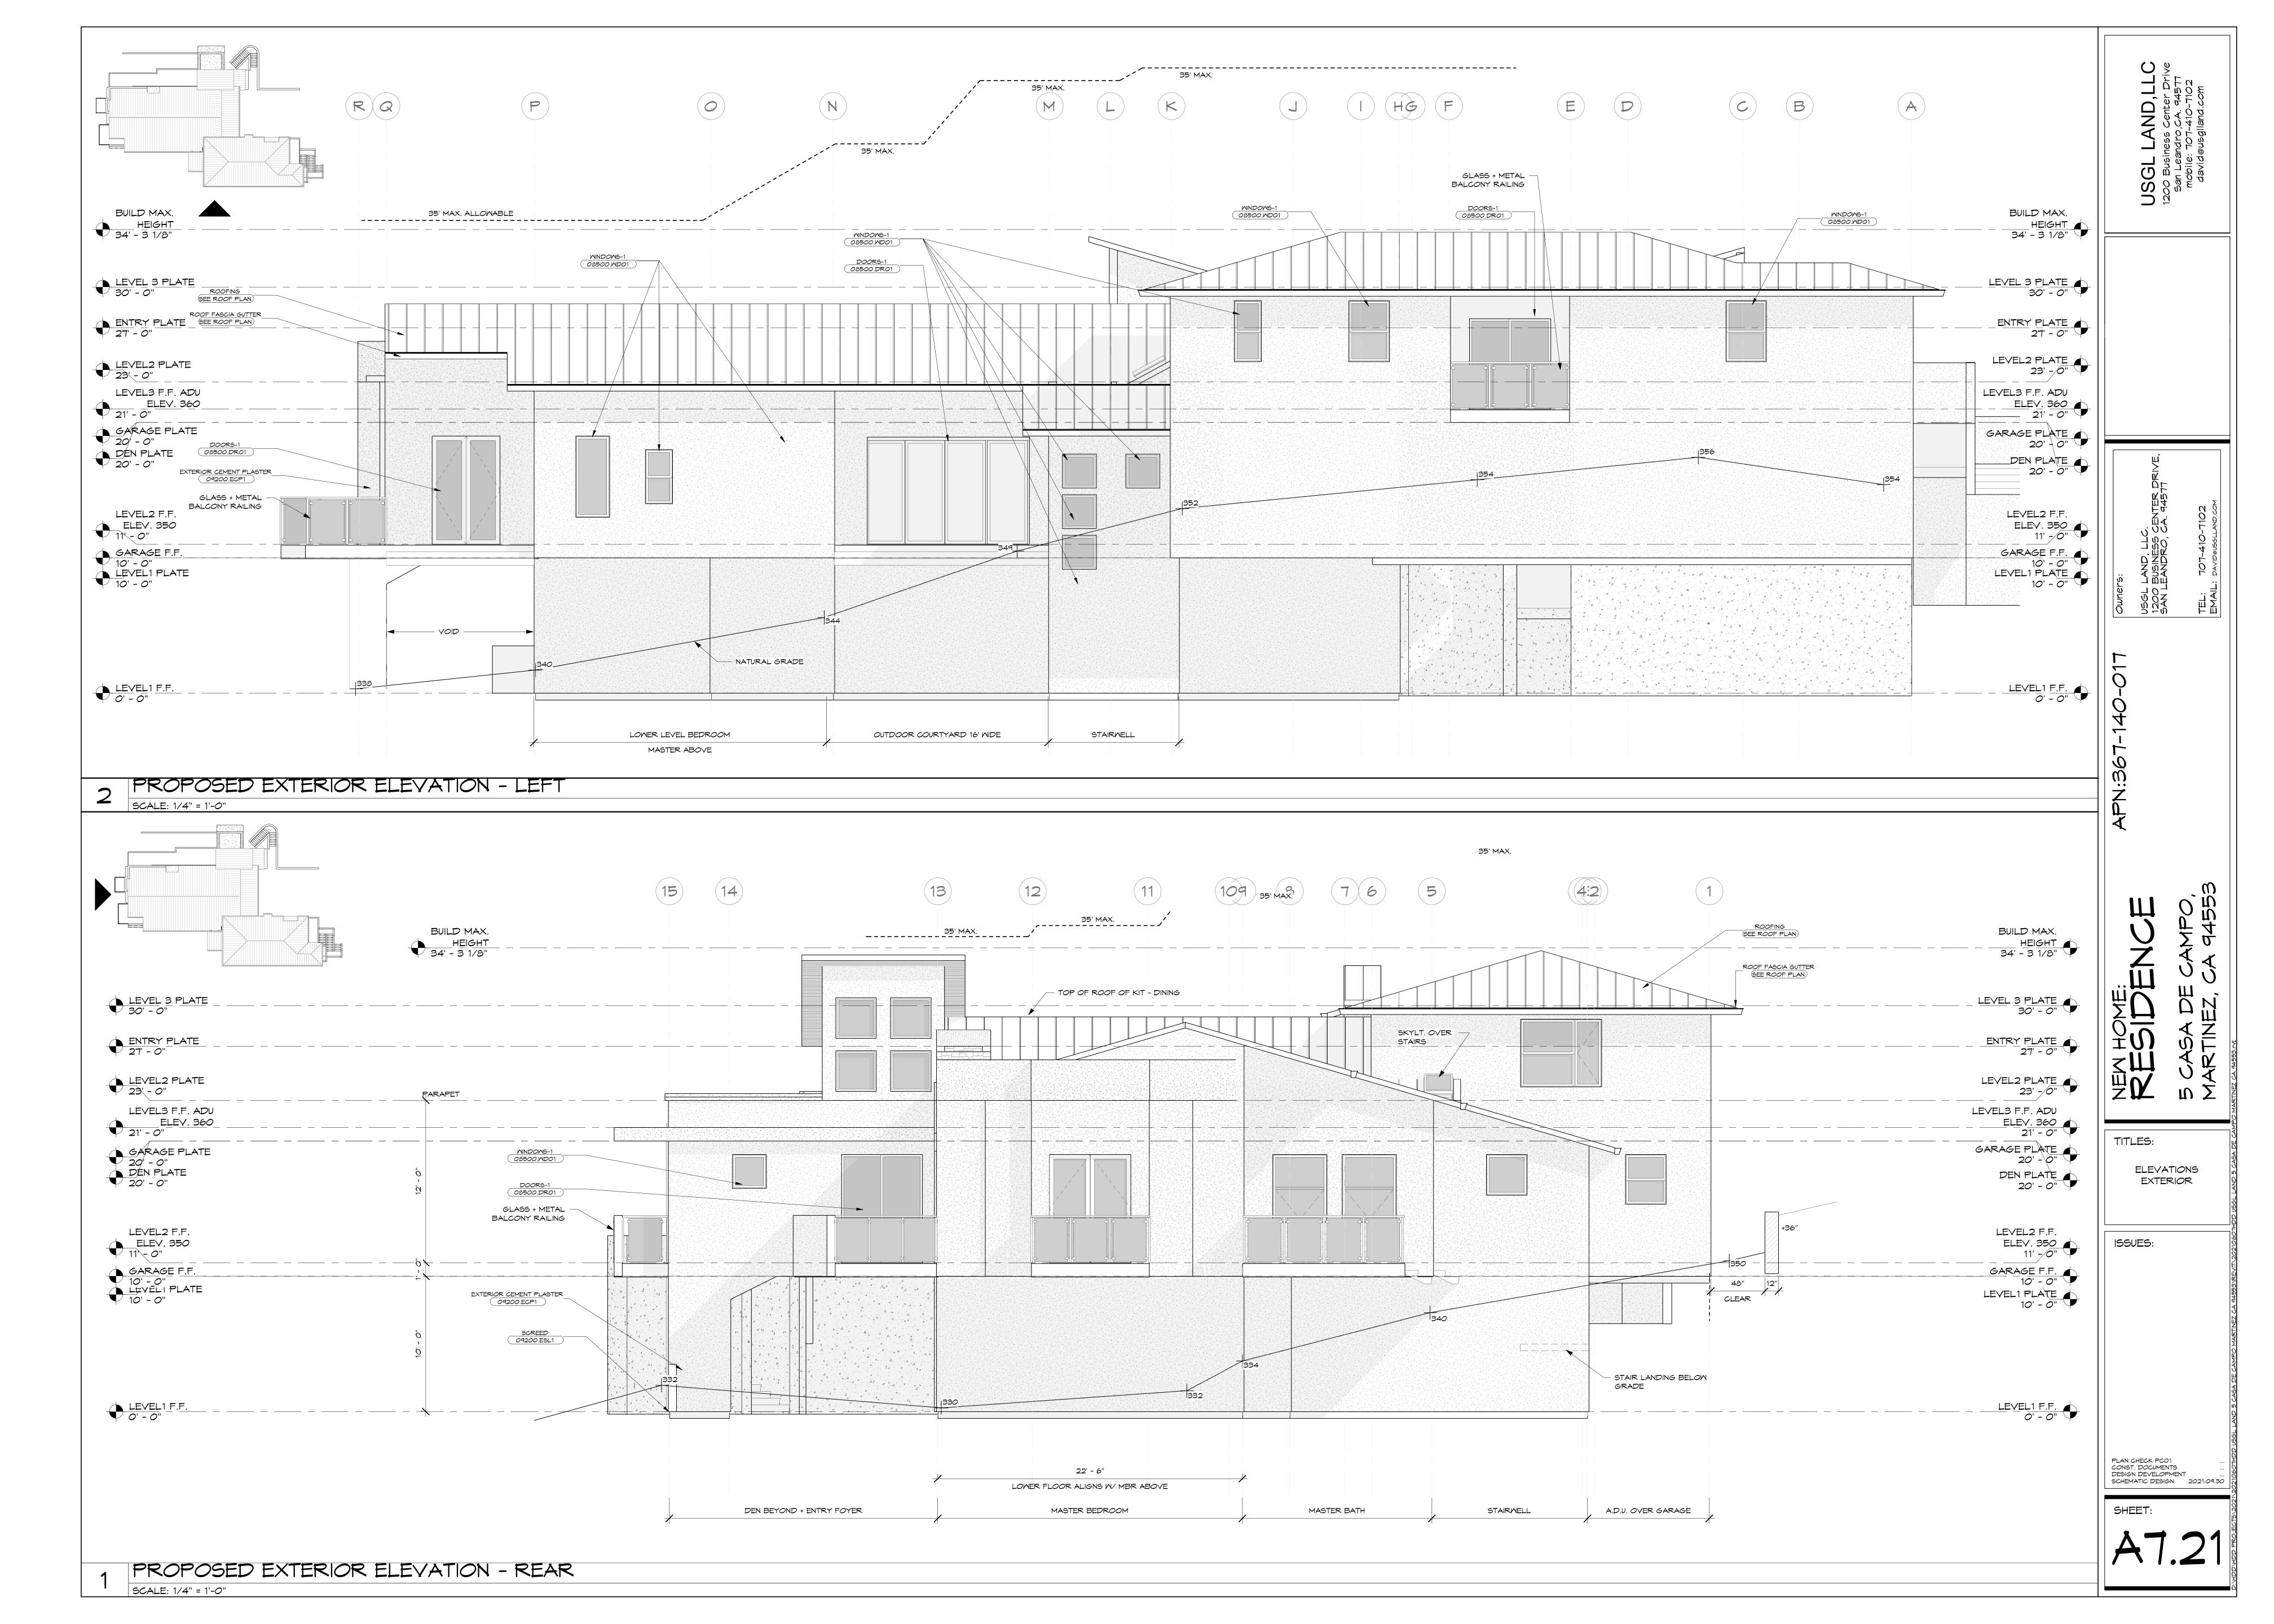

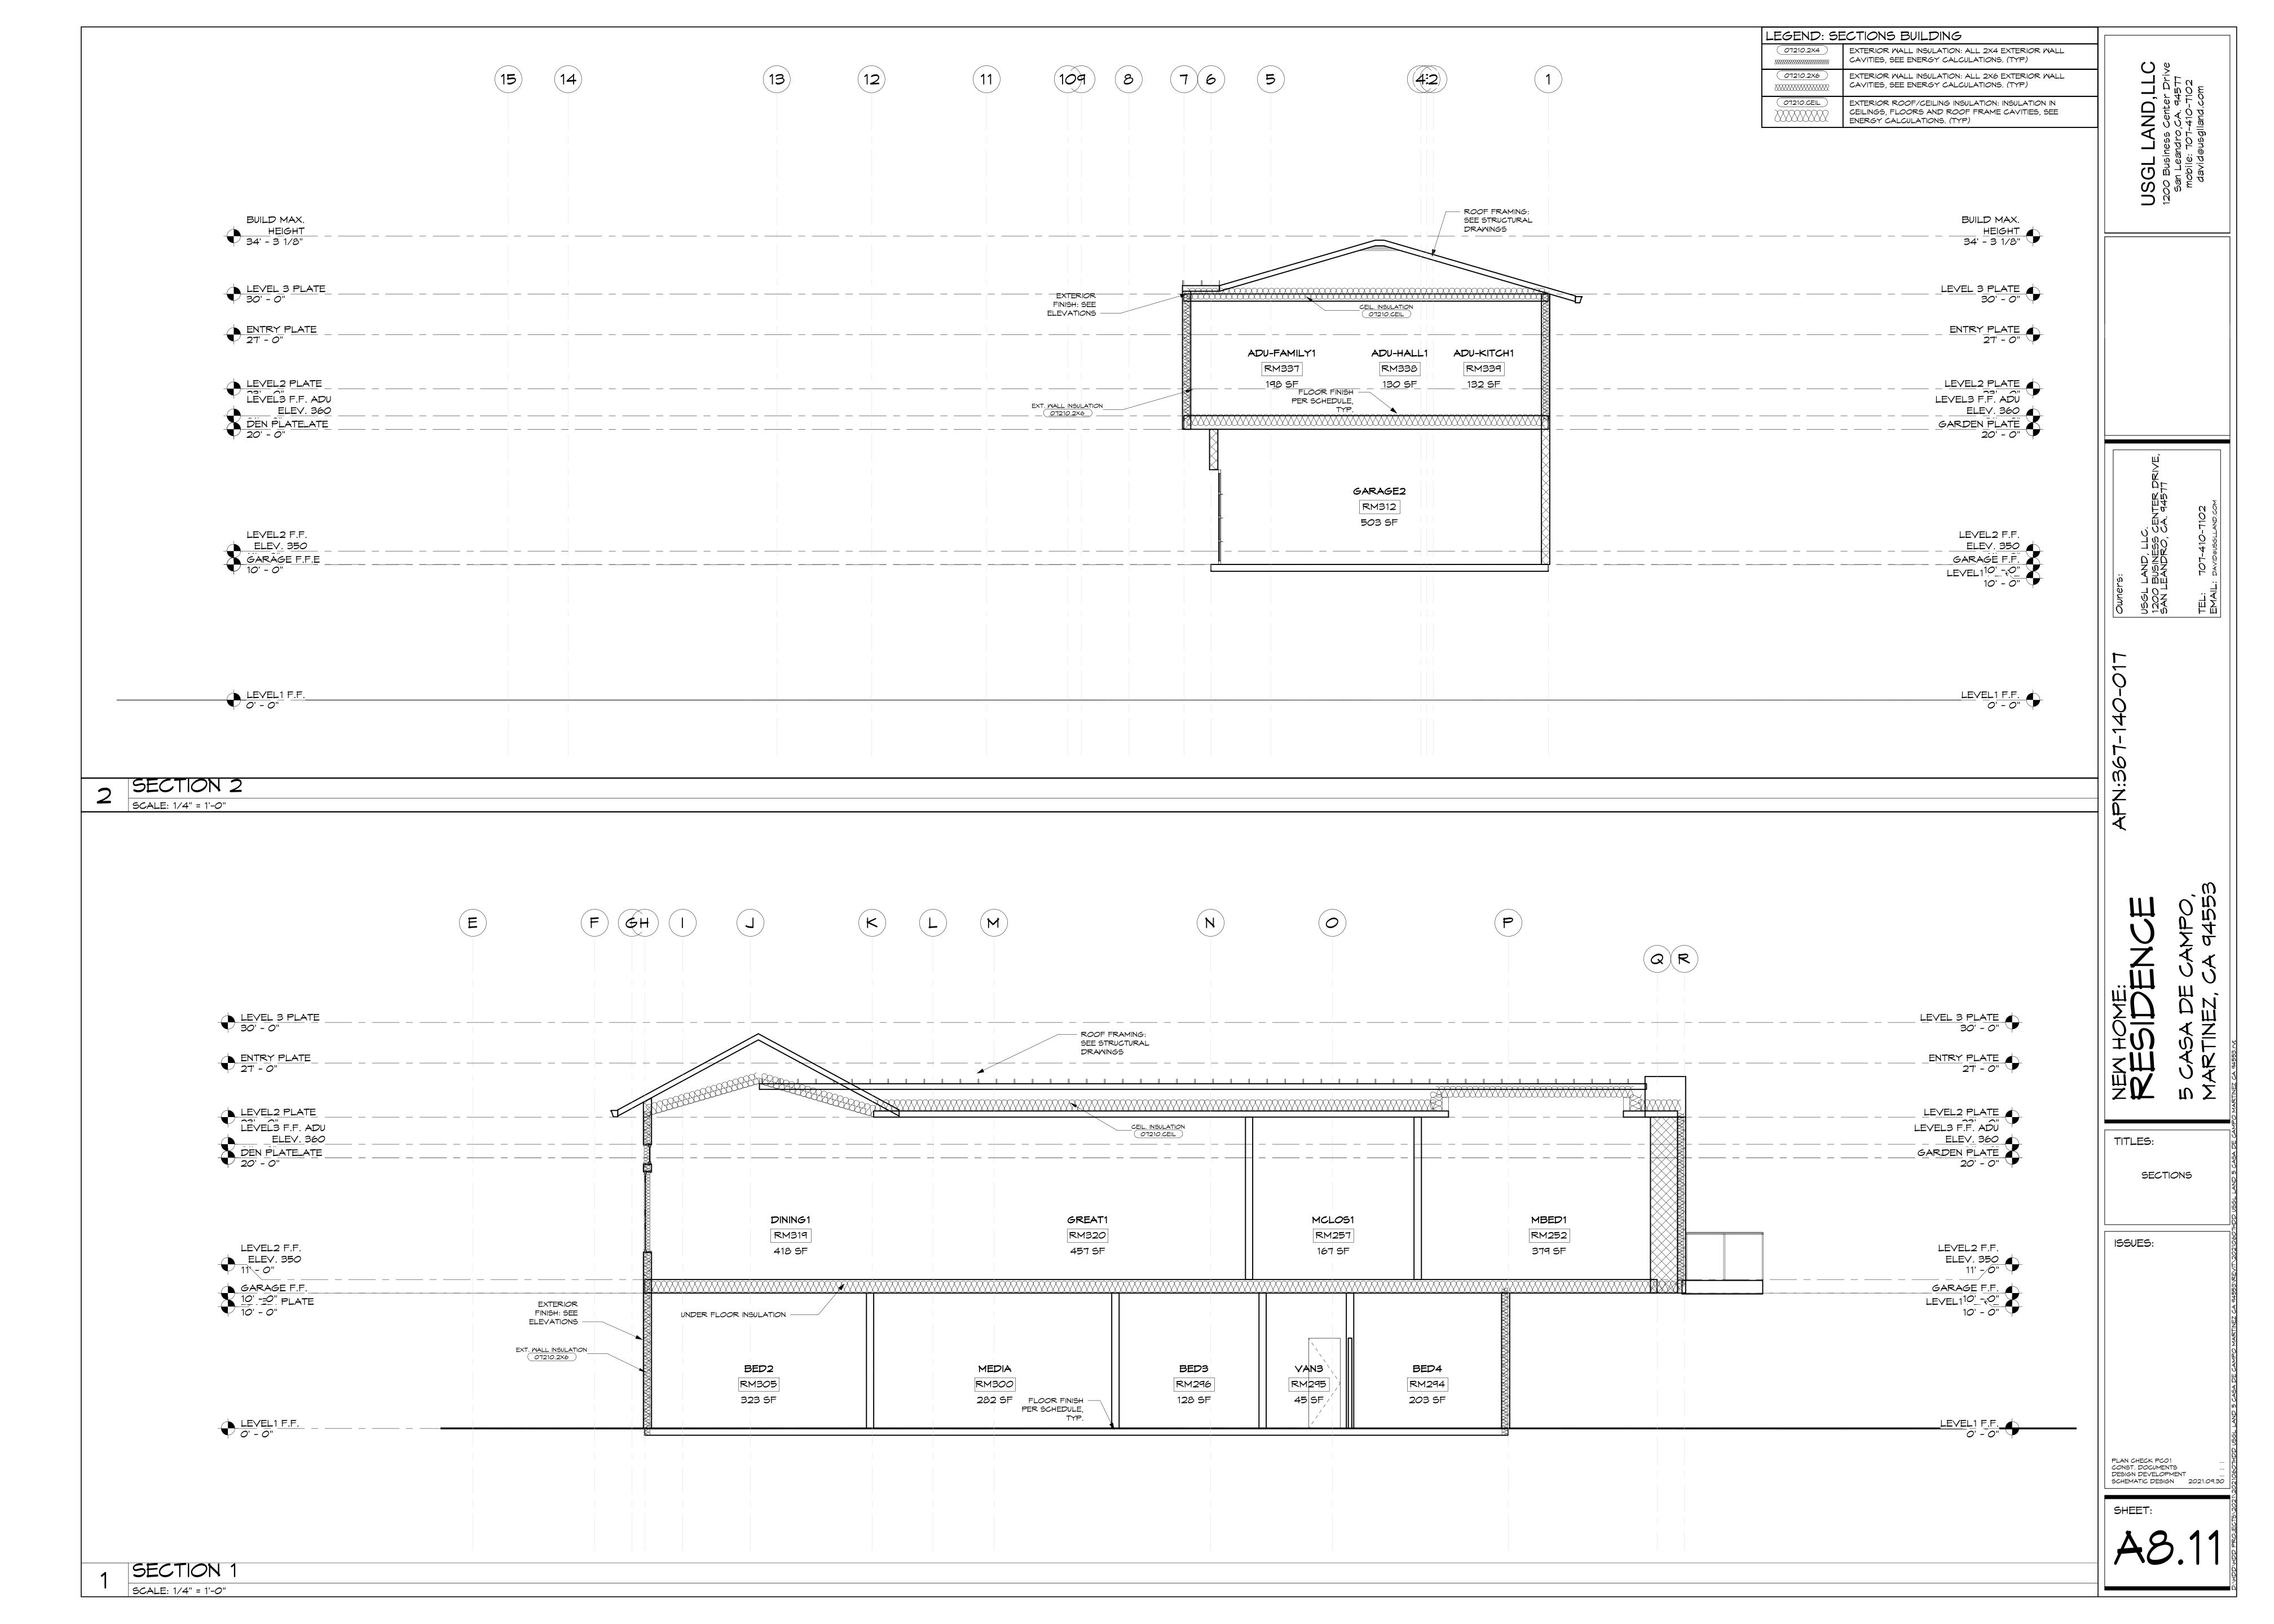

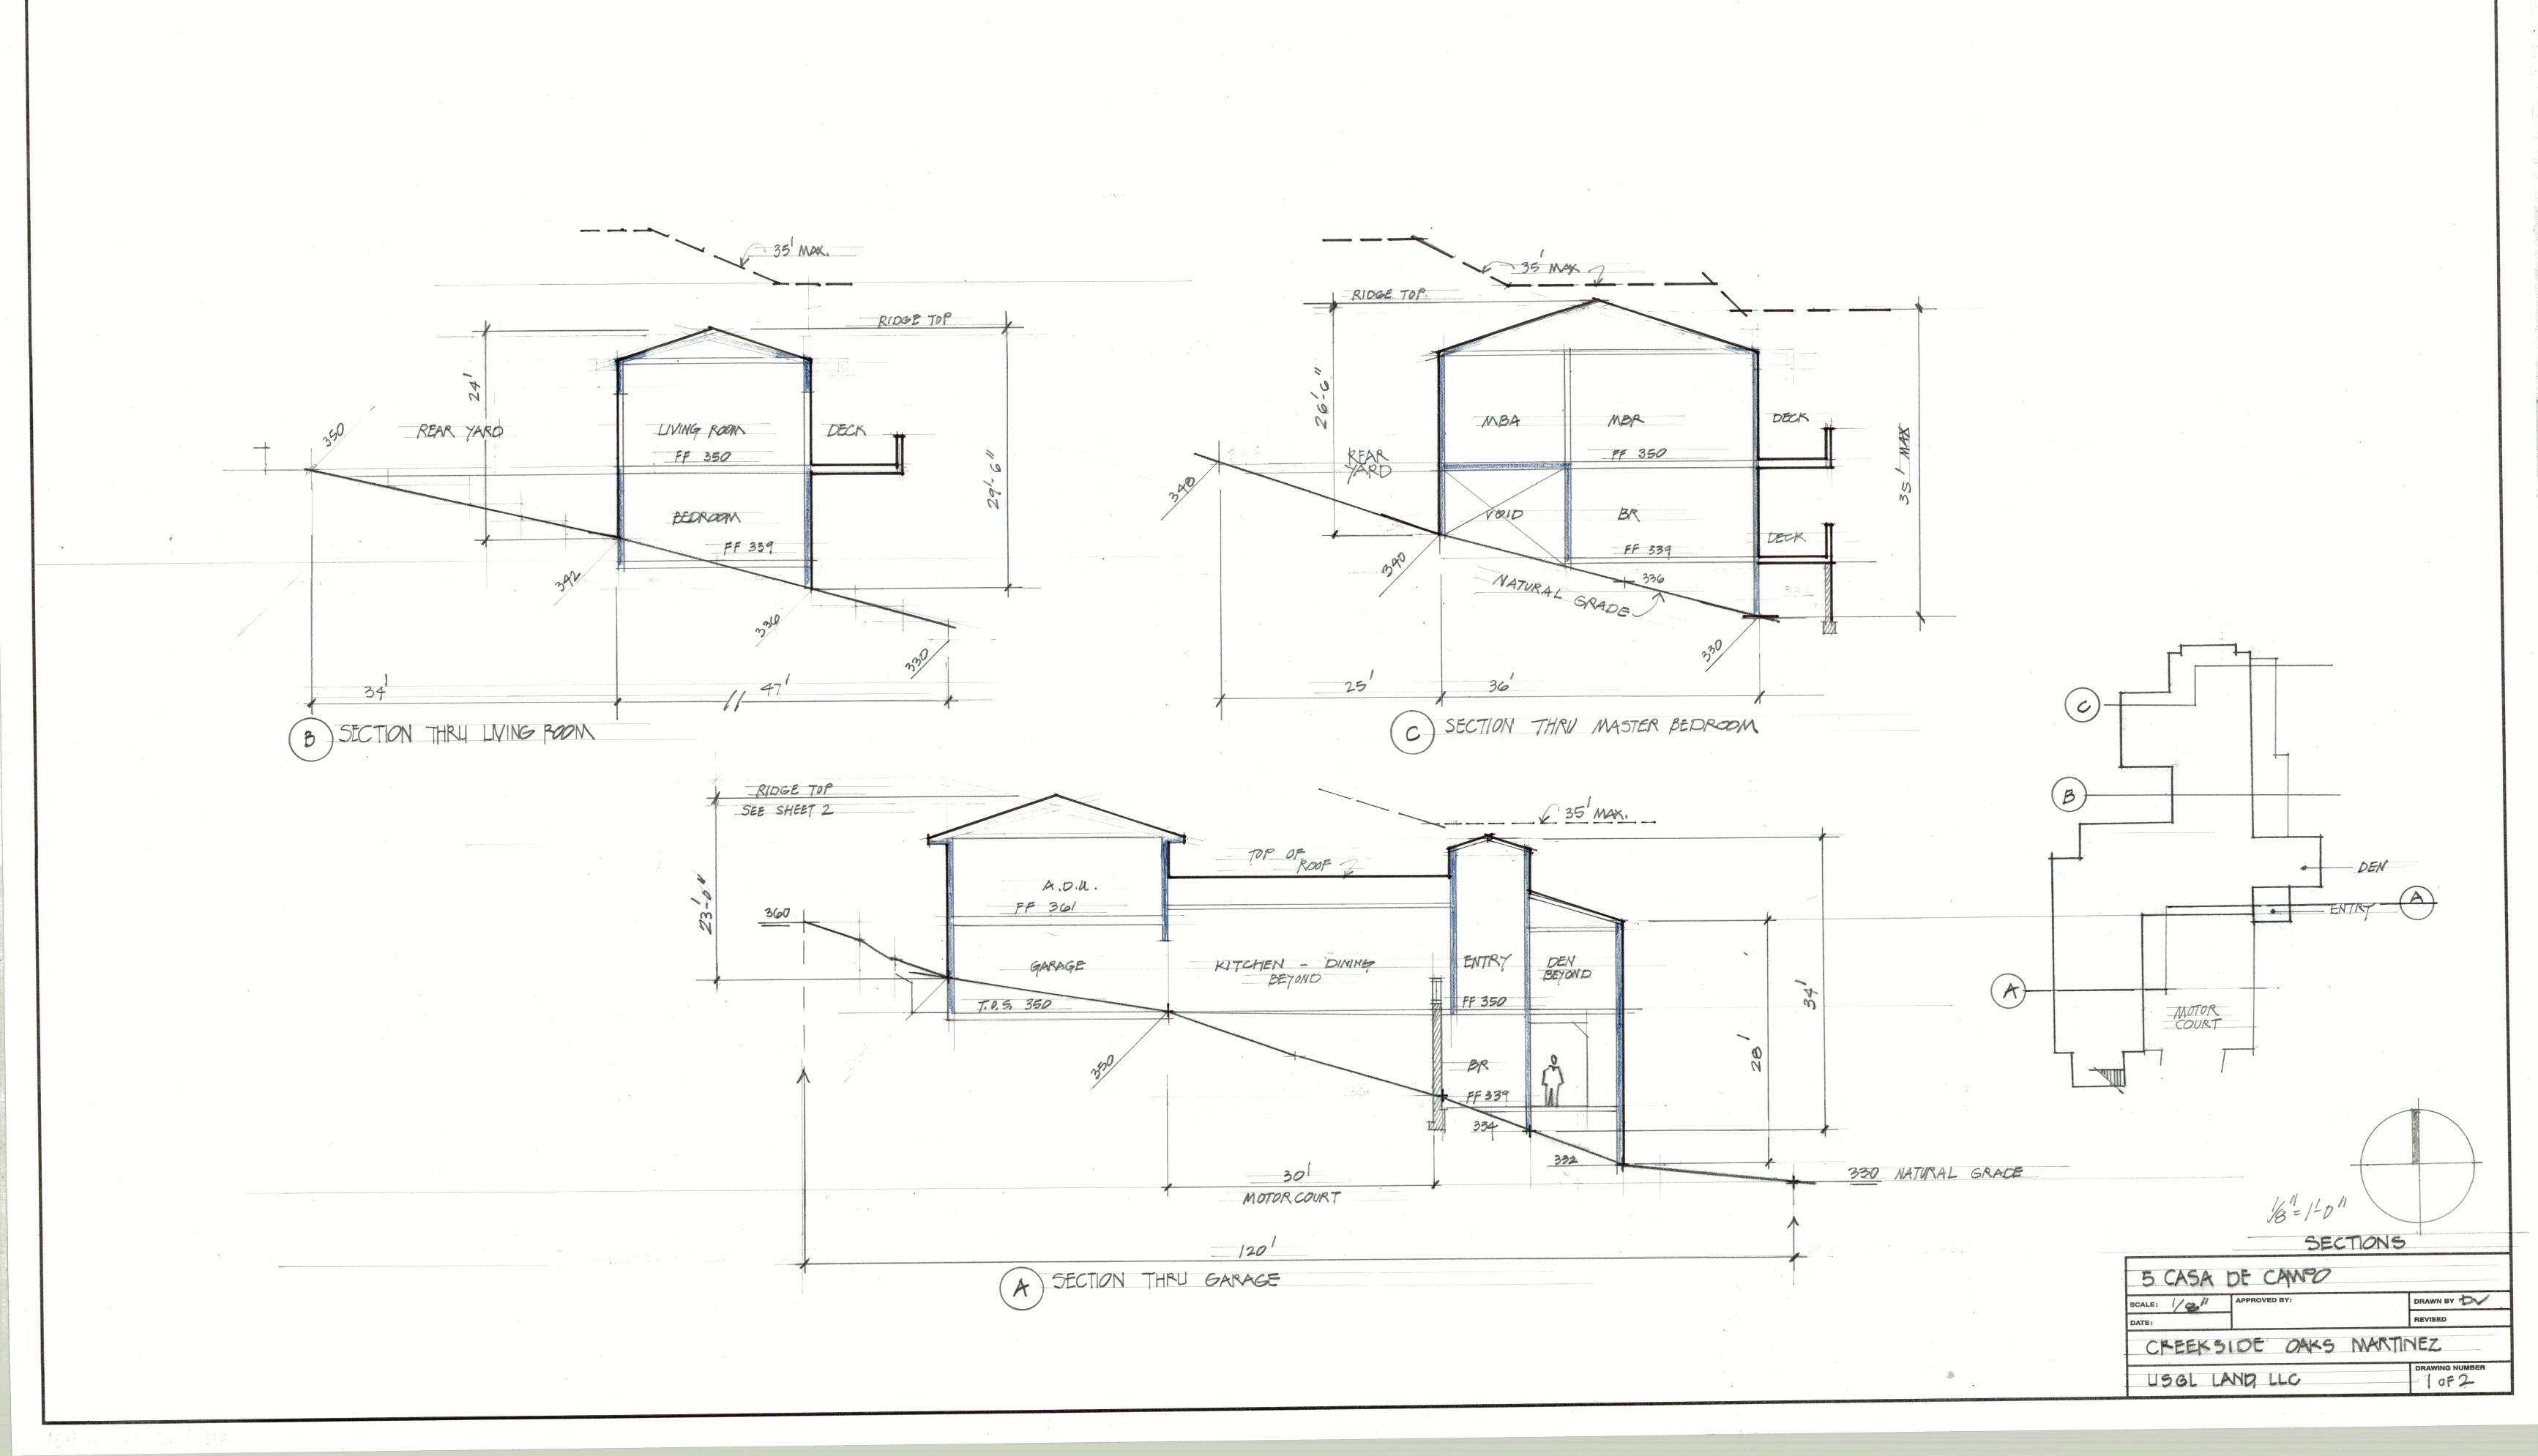

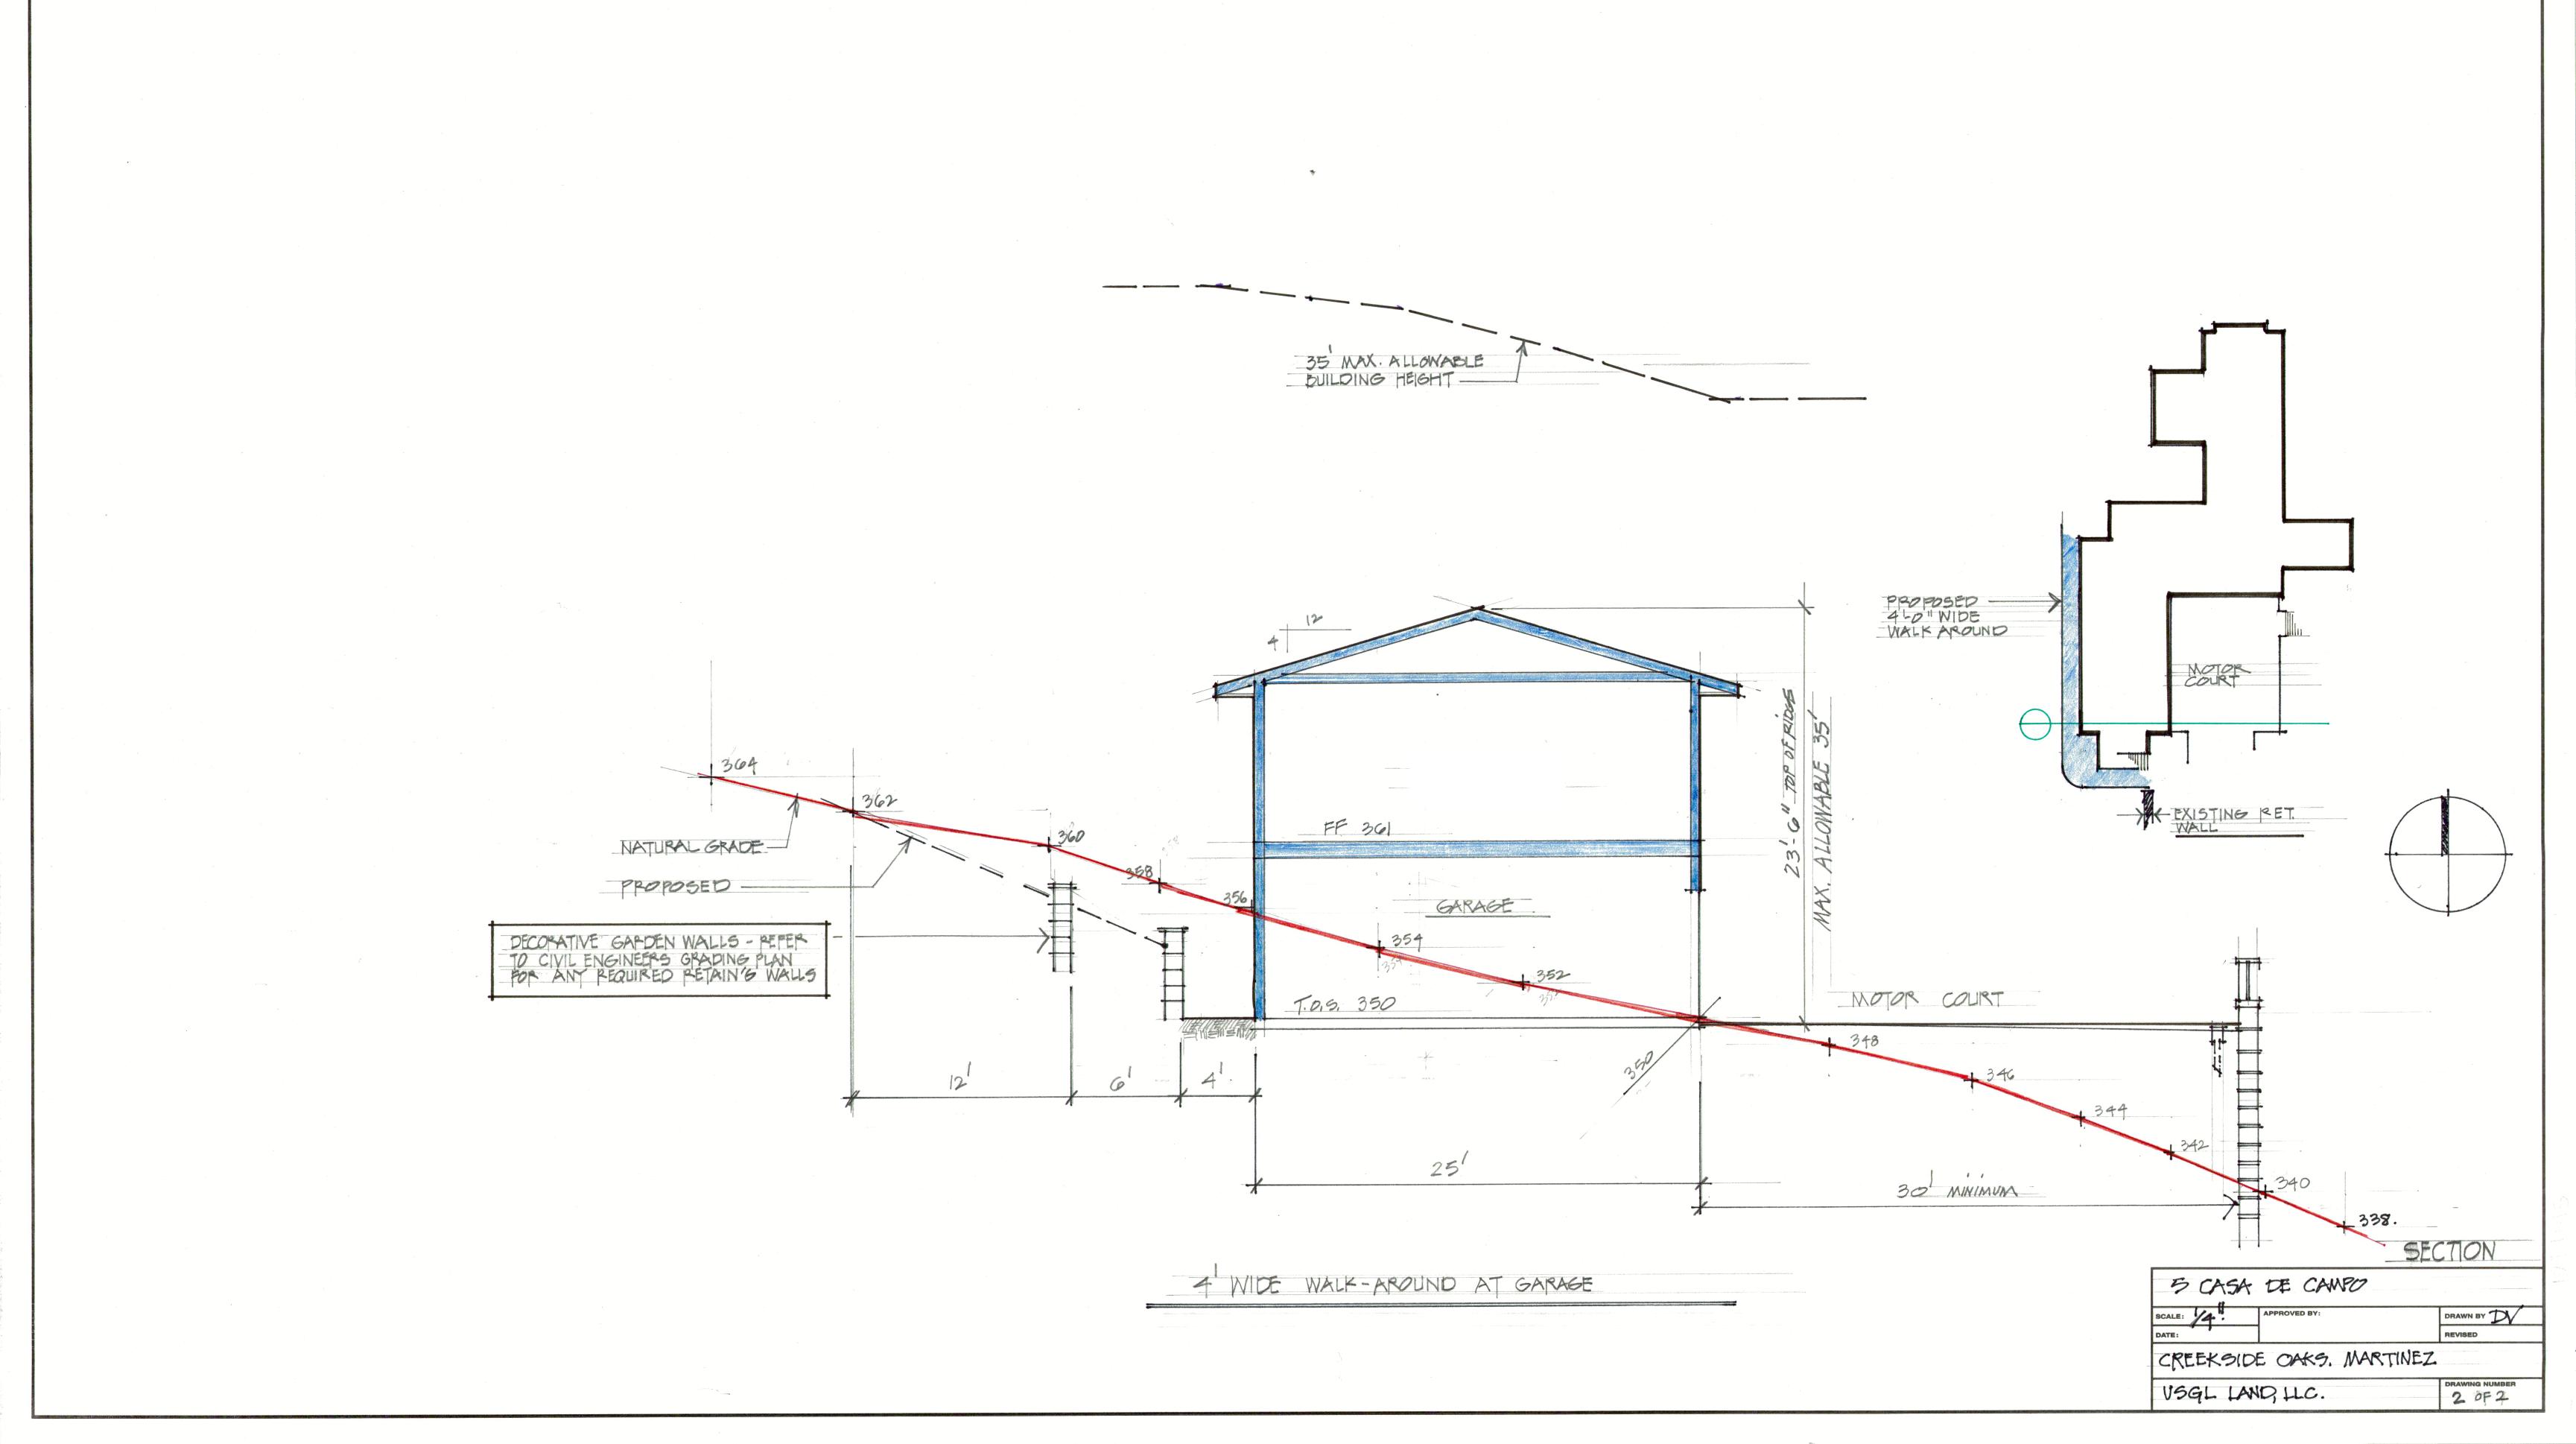

1390 SOUTH MAIN ST., SUITE 310 WALNUT CREEK, CA 94596 PHONE: (925) 476-2300 FAX : (925) 476-2350

BASIS OF BEARINGS:

THE BEARING OF NORTH 05°30'50" WEST AS DETERMINED BETWEEN TWO FOUND RAILROAD SPIKES ALONG THE CENTER LINE OF CASTLE CREEK COURT, AS SHOWN UPON THAT CERTAIN MAP SUBDIVISION NO. 6060 - CORTE MADERA, FILED FOR RECORD IN BOOK 280 OF MAPS, AT PAGE 17, OFFICIAL RECORDS OF CONTRA COSTA COUNTY. WAS TAKEN AS THE BASIS OF BEARINGS FOR THIS SURVEY.

BENCHMARK:

CCCO. BM # 3740 CCCO FASTENER & TAG ON NORTH EDGE OF CONCRETE
DRIVEWAY TO HOUSE #5. DRIVEWAY IS ON EAST SIDE PRIVATE LANE 160' +/-SOUTH OF ALHAMBRA VALLEY ROAD 0.5 MILES WEST OF INTERSECTION RELIEZ VALLEY ROAD & ALHAMBRA VALLEY ROAD. ELEV.=293.373

ABBREVIATIONS

AGGREGATE BASE ASPHALT CONCRETE

BEGINNING OF VERTICAL CURVE ELEVATION BEGINNING OF VERTICAL CURVE STATION BOTTOM OF WALL AT FINISH GRADE

CATCH BASIN CLEANOUT CENTERLINE

CONTRA COSTA COUNTY

CCCFCD CONTRA COSTA COUNTY FLOOD CONTROL DISTRICT

CONTRA COSTA WATER DISTRICT DRIVEWAY

ELEV ELEVATION

EΡ EDGE OF PAVEMENT

END OF VERTICAL CURVE ELEVATION END OF VERTICAL CURVE STATION

EX, (E) EXISTING

FLOWLINE

GR GRATE HYDRAULIC GRADE LINE

INV INVERT

JOINT TRENCH LENGTH

LINEAR FEET

LENGTH OF VERTICAL CURVE LVC

MAXMAXIMUM MIN MINIMUM

NTS NOT TO SCALE

OHE OVERHEAD ELECTRIC

0/S OFFSET

PRIVATE ACCESS AND UTILITY EASEMENT PAUE РC POINT OF CURVATURE

PUBLIC UTILITY EASEMENT PUE PR PROPOSED

PRC POINT OF REVERSE CURVATURE

PSDE PRIVATE STORM DRAIN EASEMENT PΤ

POINT OF TANGENCY PVIPOINT OF VERTICAL INFLECTION

RADIUS

R/W RIGHT OF WAY SBD SUBDRAIN

SD STORM DRAIN

SDDI STORM DRAIN DRAINAGE INLET SDE STORM DRAIN EASEMENT

SLOPE

S.O. SIDE OPENING

SS SANITARY SEWER SSE SANITARY SEWER EASEMENT

SSMH SANITARY SEWER MANHOLE

STR STRUCTURE SW SIDEWALK

STA STATION TC TOP OF CURB


TOP TOP OF BANK TRC TOP OF ROLLED CURB

TYP TYPICAL


TOP OF WALL WATER

5 CASA DE CAMPO

LOT 3 - CREEKSIDE OAKS GRADING PLANS

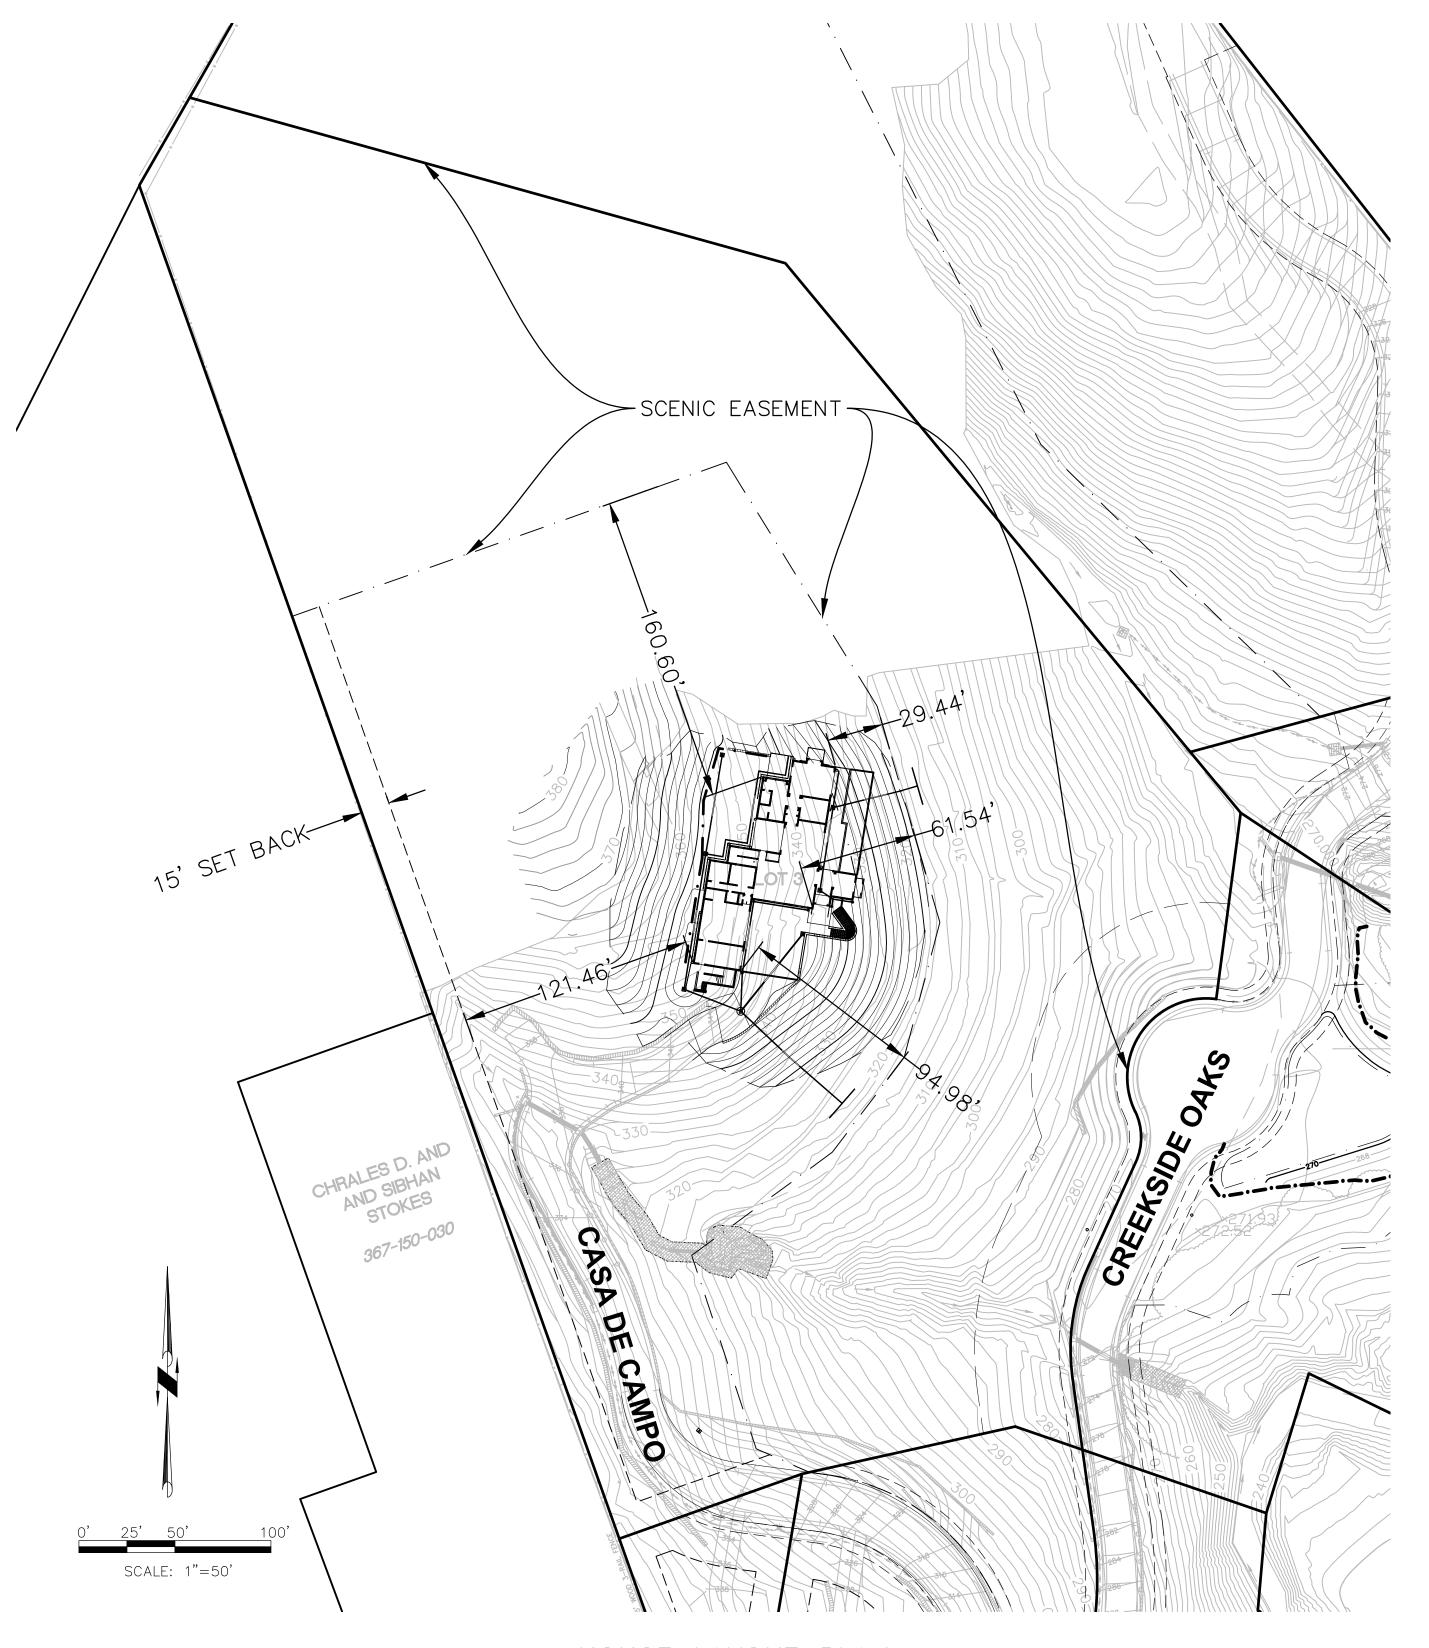

HOUSE LAYOUT PLAN SCALE 1"=50'

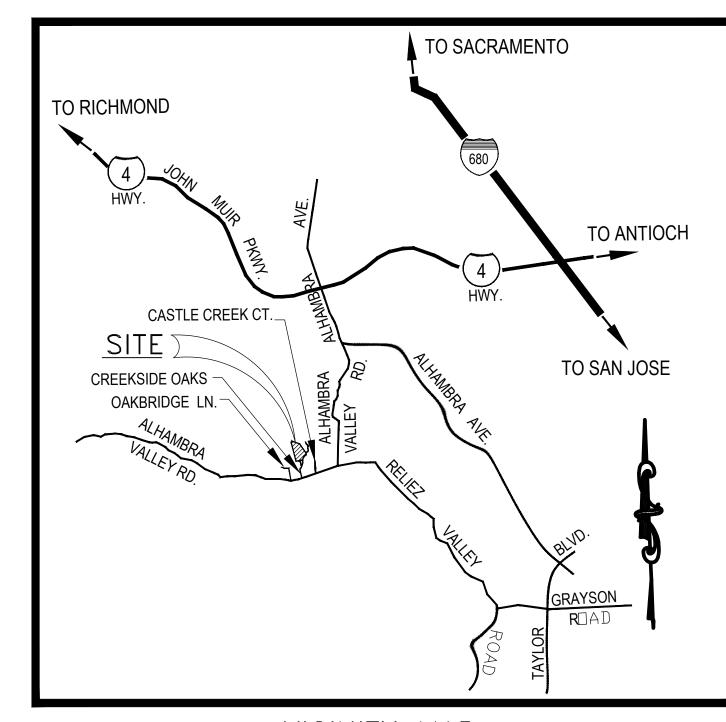

VICINITY MAP NO SCALE

INDEX:

- 1 TITLE SHEET
- 2 GENERAL NOTES
- 3 GRADING PLAN 4 DETAILS
- 5 EROSION CONTROL PLAN
- 6 TOPOGRAPHIC SURVEY

LEGEND

PROPOSED	
	PROPERTY LINE
	LOT LINE
وإصراها إصراها إصراها إصراها إصراها إصراها	STORM DRAIN LINE
###-	SUBDRAIN
•••—	CONCRETE DITCH
E	UNDERGROUND ELECTRICAL
SS	SANITARY SEWER LINE
SS LAT	SANITARY SEWER LATERAL
W	WATER LINE
W LAT	WATER LATERAL
G	GAS LINE
	RETAINING WALL
	DAYLIGHT LINE
	LANDSCAPE DRAIN
•	CATCH BASIN

CLEANOUT WITH SCREWCAP SANITARY SEWER MANHOLE STORM DRAIN MANHOLE POWER POLE FIRE HYDRANT WATER METER

PROPOSED GRADES RUNOFF DIRECTION

JOINT POLE

ELECTROLIER

WATER VALVE

GUY WIRE

EXISTING

— SS — SANITARY SEWER LINE CATCH BASIN

SANITARY SEWER MANHOLE STORM DRAIN MANHOLE POWER POLE JOINT POLE GUY WIRE ELECTROLIER

WATER VALVE FIRE HYDRANT WATER METER EXISTING GRADES

EXISTING TREE & DRIP LINE


FLOW LINE


EXISTING TREE TO BE REMOVED



ALIQUOT 1390 S. Main St. - Ste. 310 Walnut Creek, CA 94596 Telephone: (925) 476-2300 Fax: (925) 476-2350 **Civil Engineers Traffic Engineers**

Surveyors

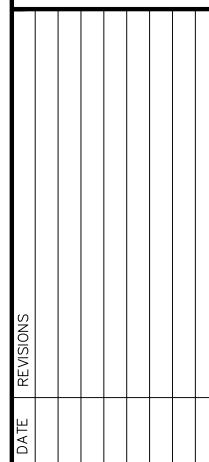

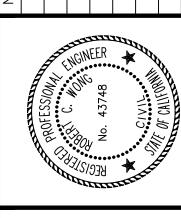

DRAWING NUMBER

GENERAL NOTES:

- 1. ELEVATIONS SHOWN ARE BASED UPON CCCO. BM # 3740 CCCO FASTENER & TAG ON NORTH EDGE OF CONCRETE DRIVEWAY TO HOUSE #5. DRIVEWAY IS ON EAST SIDE PRIVATE LANE 160' +/- SOUTH OF ALHAMBRA VALLEY ROAD 0.5 MILES WEST OF INTERSECTION RELIEZ VALLEY ROAD & ALHAMBRA VALLEY ROAD. ELEV.=293.373
- 2. ALL GRADING, SITE PREPARATION, PLACING AND COMPACTION OF FILL TO BE DONE IN ACCORDANCE WITH CONTRA COSTA COUNTY GRADING ORDINANCE NO. 99-46; ALSO UNDER THE DIRECT OBSERVATION OF THE SOIL ENGINEER. SUBSEQUENT TO COMPLETION OF THE WORK, THE SOIL ENGINEER SHALL SUBMIT TO THE COUNTY BUILDING INSPECTION DEPARTMENT A REPORT STATING THAT ALL WORK HAS BEEN DONE TO HIS/HER SATISFACTION.
- 3. ALL GRADING, SITE PREPARATION, PLACING AND COMPACTION OF FILL, TO BE DONE IN ACCORDANCE WITH CONTRA COSTA COUNTY GRADING ORDINANCE NO. 99-46, UNDER THE DIRECT OBSERVATION OF THE COUNTY SENIOR GRADING
- 4. CONTRACTOR TO NOTIFY CONTRA COSTA COUNTY GRADING SECTION 48-HOURS PRIOR TO START OF WORK. (SCHEDULE A #600 PRE-CONSTRUCTION MEETING INSPECTION)
- 5. ALL CUT SLOPES SHALL BE ROUNDED TO MEET EXISTING GRADES AND BLEND WITH SURROUNDING TOPOGRAPHY. ALL GRADED SLOPES SHALL BE PLANTED WITH SUITABLE GROUND COVER.
- 6. ANY DEVIATION FROM APPROVED PLAN REQUIRES APPROVAL OF THE CONTRA COSTA COUNTY DEPARTMENT OF CONSERVATIONS AND DEVELOPMENT (CCCDCD) PLANNING DIVISION AND GRADING SECTION PRIOR TO ANY CHANGES OCCURRING AT THE PERMITTED SITE.
- 7. ALL SLIDE REPAIR WORK, KEYWAYS, SUBDRAIN INSTALLATION, AND BUTTRESS FILLS WORK SHALL BE INSPECTED BY THE GRADING SECTION. REPORT FROM THE SOIL ENGINEER SHALL BE SUBMITTED TO THE GRADING SECTION REGARDING THE SLIDE REPAIR AND/OR SUBDRAIN INSTALLATION, AND A SCALED DRAWING OF THE HORIZONTAL AND VERTICAL LOCATION OF ALL KEYWAY EXCAVATIONS, AND ALL SUBDRAIN IMPROVEMENT INSTALLATION.
- DURING GRADING OPERATIONS. CONTRACTOR SHALL IMPLEMENT DUST CONTROL MEASURES ON SITE AND HAUL ROUTES, AND ALL OTHER STORM WATER POLLUTION PREVENTION REGULATIONS DURING DRY SEASONS.
- 9. A 601 ROUGH GRADE INSPECTION APPROVAL REQUIRED PRIOR TO THE COMMENCEMENT OF ANY FOUNDATION CONSTRUCTION ACTIVITY UNDER ANY SEPARATE BUILDING PERMIT.
- 10. A FINAL REPORT BY THE CIVIL ENGINEER CERTIFYING THAT ALL GRADING, LOT DRAINAGE AND DRAINAGE FACILITIES HAVE BEEN COMPLETED AND THE SLOPE PLANNING INSTALLED IN CONFORMANCE WITH THE APPROVED PLANS, SHALL BE SUBMITTED TO THE COUNTY PRIOR TO ISSUANCE OF BUILDING PERMITS.
- 11. EROSION AND SEDIMENT CONTROL PLANS ARE REQUIRED DURING ALL SEASONS. COMPLIANCE TO STATE, COUNTY, AND LOCAL GOVERNMENT STORM WATER POLLUTION PREVENTION REGULATIONS IS AT ALL TIMES (YEAR ROUND). PROTECTION OF ALL BARE SOILS IS REQUIRED OCTOBER 1ST THROUGH MAY 1ST, AND IN THE EVENT OF AN EXTENDED RAINY SEASON.
- 12. IF THERE ARE ANY EXISTING WATER WELLS ON THIS PROPERTY, THE PROPERTY OWNER SHALL CONTACT THE COUNTY DEPARTMENT OF HEALTH SERVICES, ENVIRONMENTAL HEALTH DIVISION, PRIOR TO ANY GRADING IN THE IMMEDIATE VICINITY OF THESE WELLS.
- 13. THE COUNTY ENGINEER OR DESIGNEE MAY ENTER THE PREMISES OF THE WORK AT ALL TIMES TO INSPECT THE CONDITION OF THE SITE AND THE METHODS OF OPERATION AND TO CHECK OR TEST ANY FEATURE OR OPERATION INVOLVED IN FULFILLING THE CONDITITONS OF THE GRADING PERMIT.
- 14. WHERE FREQUENT OR CONTINUOUS INSPECTION DURING CONSTRUCTION IS NECESSARY TO INSURE COMPLIANCE WITH THE GRADING PERMIT. THE APPLICANT WHEN SO DIRECTED, SHALL HAVE A QUALIFIED SOILS ENGINEER FURNISH CONTINUOUS SUPERVISION AND INSPECTION OF THE WORK, AND MAKE ALL THE NECESSARY FIELD TESTS DURING GRADING OPERATIONS.
- 15. IN ADDITION TO THE REQUIREMENTS OF THE GRADING PERMIT THE PERMITTEE SHALL COMPLY WITH ALL APPLICABLE LAWS, ORDINANCES, AND REGULATIONS OF THE STATE AND COUNTY RELATING TO THE CHARACTER OF THE WORK, EQUIPMENT, AND LABOR PERSONNEL INVOLVED IN THE PROJECT.
- 16. OPERATIONS SHALL BE CONTROLLED TO PREVENT NUISANCES TO PUBLIC AND PRIVATE OWNERSHIPS BECAUSE OF DUST, DRAINAGE, REMOVAL OF NATURAL SUPPORT OF LAND AND STRUCTURES, ENCROACHMENTS, NOISE AND
- 17. ALL GRADING OPERATIONS SHALL CONFORM TO THE RECOMMENDATIONS OF THE GEOTECHNICAL ENGINEER AND ARE SUBJECT TO HIS OBSERVATION.
- 18. THE CONTRACTOR IS REQUIRED TO TAKE DUE PRECAUTIONARY MEASURES TO PROTECT THE UTILITIES OR STRUCTURES SHOWN AND ANY OTHER UTILITIES NOT SHOWN AT THE SITE.
- 19. ALL ORGANIC MATERIAL, INCLUDING GRASS & WEEDS SHALL BE STRIPPED PRIOR TO ANY GRADING OPERATION AND TRANSPORTED AWAY FROM AREAS THAT ARE TO RECEIVE STRUCTURE OR ENGINEERED FILL. STRIPPING SHALL BE USED FOR LANDSCAPING, MOUNDING, AND OR BLENDING AND USED AS A FILL IN NON-STRUCTURAL AREAS.
- 20. GRADING SHALL BE STOPPED IMMEDIATELY IF DUST AFFECTS ADJACENT PROPERTIES. SUFFICIENT WATERING TO CONTROL DUST IS REQUIRED AT ALL TIMES AND A DUST PALLIATIVE MAY BE REQUIRED BY THE INSPECTOR. ANY OPERATION THAT CREATES DUST SHALL CEASE IMMEDIATELY UNTIL SUFFICIENT MEASURES SATISFACTORY TO THE COUNTY HAVE BEEN TAKEN TO INSURE COMPLIANCE WITH THE DUST CONTROL REQUIREMENT'S.
- 21. THE CONTRACTOR SHALL NOTIFY UNDERGROUND SERVICE ALERT (U.S.A.) AT LEAST 48 HOURS PRIOR TO ANY EXCAVATION. THE U.S.A AUTHORIZATION NUMBER SHALL BE KEPT AT THE JOB SITE.
- 22. SHOULD IT APPEAR THAT THE WORK TO BE DONE, OR ANY MATTER RELATIVE THERETO, IS NOT SUFFICIENTLY DETAILED OR EXPLAINED ON THESE PLANS. THE CONTRACTOR SHALL CONTACT ALIQUOT ASSOCIATES AT (925) 476-2300. FOR SUCH FURTHER EXPLANATIONS AS MAY BE NECESSARY.
- 23. THESE PLANS SHOW EXISTING FEATURES INCLUDING BUT NOT LIMITED TO, TREES, UTILITIES, AND STRUCTURES THAT MAY BE AFFECTED BY THE CONSTRUCTION OR PLACEMENT OF THE PROPOSED ENGINEERED IMPROVEMENTS. THE CONTRACTOR WILL IMMEDIATELY NOTIFY THE ENGINEER IF THERE ARE ANY EXISTING FEATURES. WHETHER SHOWN OR NOT SHOWN ON THESE PLANS. THAT COULD IN ANY WAY BE IN POTENTIAL CONFLICT WITH THE DESIGN OF THESE PLANS. ALL WORK WITHIN THE VICINITY OF A POTENTIAL CONFLICT SHALL CEASE UNTIL AN ADEQUATE AND APPROPRIATE SOLUTION IS DETERMINED BY THE ENGINEER AND APPROVED BY THE COUNTY ENGINEER.
- 24. IT IS THE CONTRACTOR'S RESPONSIBILITY TO VERIFY EARTH QUANTITIES INDEPENDENTLY TO HIS OWN SATISFACTION PRIOR TO CONSTRUCTION. CONTRACTOR SHALL BE RESPONSIBLE FOR COSTS ASSOCIATED WITH DISCREPANCIES IN CUT/FILL EARTH QUANTITIES.

FARTHWORK QUANTITIES: CUT=±2.100 C.Y. FILL=±2,265 C.Y.

- 25. ALL CONSTRUCTION EQUIPMENT AND HAUL TRUCKS SHALL BE MAINTAINED AND PROPERLY TUNED IN ACCORDANCE WITH MANUFACTURER'S SPECIFICATIONS. ALL CONSTRUCTION EQUIPMENT AND HAUL TRUCKS SHALL BE CHECKED BY A CERTIFIED MECHANIC AND DETERMINED TO BE RUNNING IN PROPER CONDITION PRIOR TO OPERATION
- 26. A PUBLICLY VISIBLE SIGN SHALL BE POSTED WITH THE TELEPHONE NUMBER OF THE CONSTRUCTION MANAGER AND BAAQMD TO REPORT DUST COMPLAINTS. THIS PERSON SHALL RESPOND AND TAKE CORRECTIVE ACTION WITHIN 48 HOURS. THE BAAQMD COMPLAINT LINE TELEPHONE NUMBER SHALL ALSO BE VISIBLE TO ENSURE COMPLIANCE WITH APPLICABLE REGULATIONS.
- 27. ALL ON-SITE STORAGE OF EXCAVATED SOIL SHALL BE COVERED AND WATERED AT LEAST ONCE PER DAY OR IF NECESSARY TWICE PER DAY, DURING CONSTRUCTION, ALL TRUCKS STANDING FOR FIVE MINUTES OR MORE, EXCEPT CEMENT TRUCKS, SHALL SHUT OFF THEIR MOTORS.
- 28. TOTAL SQUARE FOOTAGE OF LAND DISTURBANCE = 25,000± SQUARE FEET.
- 29. BY ACCEPTING THIS PERMIT, THE PERMITTEE, FOR HIMSELF, HIS CONTRACTORS, AND EMPLOYEES, PROMISES TO SAVE, INDEMNIFY AND HOLD HARMLESS THE COUNTY OF CONTRA COSTA AND ITS EMPLOYEES, AGENTS AND REPRESENTATIVES FROM ALL LIABILITIES AND CLAIMS FOR DAMAGES BY REASON IN INJURY OR DEATH TO ANY PERSON(S), OR DAMAGE TO PROPERTY, FROM ANY CAUSE WHATSOEVER WHILE IN, UPON OR IN ANY WAY CONNECTED WITH THE WORK COVERED BY THIS GRADING PERMIT, AND DOES FURTHER PROMISE TO DEFEND THESE INDEMNITEE IN ANY CLAIM OR ACTION ARISING OUT OF OR AS A RESULT OF THE WORK DONE UNDER THIS PERMIT" (CONTRA COSTA GRADING ORDINANCE CODE SECTION 716-4.1412 INDEMNITY CLAUSE REQUIRED.)

ALIQUOT ASSOCIATES INC. GENERAL NOTES:

UNDERGROUND UTILITIES

- 1. EXISTING PRIVATE AND PUBLIC UTILITIES SHOWN HEREON REFLECT AVAILABLE RECORD DATA. THE CONTRACTOR SHALL BE RESPONSIBLE FOR LOCATING AND PROTECTING ALL UTILITIES WHICH ARE TO REMAIN IN USE, WHETHER OR NOT SHOWN HEREON. THE CONTRACTOR SHALL NOTIFY ALL PUBLIC UTILITY COMPANIES AND OWNERS OF PRIVATE UTILITIES WITHIN THE CONSTRUCTION AREA 48 HOURS PRIOR TO START OF ANY
- ANY EXCAVATION. THE USA AUTHORIZATION NUMBER SHALL BE KEPT AT THE JOB SITE.
- 3. IT SHALL BE THE CONTRACTOR'S RESPONSIBILITY TO NOTIFY ALIQUOT ASSOC., INC. OF ANY DIFFERENCES IN LOCATIONS OF EXISTING UTILITIES SHOWN. OR ANY CONFLICTS WITH THE DESIGN BEFORE CONTINUING WORK IN
- THAT THERE IS AN ADEQUATE CLEARANCE FOR KNOWN CROSSINGS OF OTHER UTILITIES BEFORE CONSTRUCTING NEW PIPELINES.
- 5. PRIOR TO CONSTRUCTION, THE CONTRACTOR SHALL VERIFY THE FLOW LINE ELEVATION OF THE EXISTING SEWER AND STORM DRAIN AT THE POINT OF CONNECTION AND NOTIFY THE ENGINEER IMMEDIATELY IF MORE THAN 0.10 FOOT OF DIFFERENCE EXISTS FROM THIS PLAN.
- OBSTRUCTIONS INDICATED ARE FOR INFORMATION ONLY. IT IS THE CONTRACTOR'S RESPONSIBILITY TO VERIFY THE LOCATION AND DEPTH WITH THE APPROPRIATE AGENCIES.

UPSTREAM TERMINUS.

- 10. THE PROJECT SHALL COMPLY WITH THE DUST CONTROL REQUIREMENTS OF THE GRADING ORDINANCE
- DAY. WATER FLUSHING OF SITE DEBRIS OR SEDIMENT OR CONCRETE WASHING IS EXPRESSLY PROHIBITED.

- 12. CONTRACTORS AND SUBCONTRACTORS SHALL FIT ALL INTERNAL COMBUSTION ENGINES WITH MUFFLERS WHICH ARE IN GOOD CONDITION IN ACCORDANCE WITH STATE AND FEDERAL REQUIREMENTS, AND SHALL LOCATE STATIONARY NOISE-GENERATING EQUIPMENT AS FAR AWAY FROM EXISTING RESIDENCES AS FEASIBLE.
- 13. THE SITE SHALL BE MAINTAINED IN AN ORDERLY FASHION FOLLOWING THE CESSATION OF CONSTRUCTION ACTIVITY, ALL CONSTRUCTION DEBRIS SHALL BE REMOVED FROM THE SITE.
- 16. PRIOR TO COMMENCEMENT OF ANY WORK ON ADJACENT PROPERTIES, THE OWNER SHALL OBTAIN WRITTEN PERMISSION FROM AFFECTED PROPERTY OWNERS.
- 17. DURING CONSTRUCTION, THE CONTRACTOR SHALL BE RESPONSIBLE FOR KEEPING MUD OR OTHER DEBRIS OFF OF THE STREETS ADJACENT TO HIS/HER PROJECT. THE STREET SHALL NOT BE USED TO STORE MATERIALS OR TO PARK CONSTRUCTION TRAILERS OR OTHER SUCH VEHICLES FOR EXTENDED PERIODS OF TIME AS PER COUNTY ORDINANCE.
- 18. THE CONTRACTOR SHALL PROVIDE EMERGENCY TELEPHONE NUMBERS FOR PUBLIC WORKS, AMBULANCE, POLICE AND FIRE DEPARTMENTS AT THE JOB SITE.

DESIGN RESPONSIBILITY

19. ALIQUOT ASSOC., INC. ASSUMES NO RESPONSIBILITY BEYOND THE ADEQUACY OF THE DESIGN CONTAINED

20. SURVEYOR PERFORMING CONSTRUCTION STAKING SHALL VERIFY ALL PROPOSED ELEVATIONS CONFORMING WITH EXISTING PAVEMENT. CURBS & PIPES AND SHALL REPORT ANY VERTICAL ELEVATIONS AND HORIZONTAL DISCREPANCIES TO THE ENGINEER AND CONTRACTOR PRIOR TO CONSTRUCTION.

RETAINING WALL STAKES

21. RETAINING WALL STAKES ARE REFERENCED TO THE TOP OF WALL (TW) AND/OR AT THE FINISHED GRADE AT THE BOTTOM OF WALL (BW), UNLESS OTHERWISE NOTED ON THE PLAN.

OR SETTLE AND SO THAT ALL EXISTING IMPROVEMENTS OF ANY KIND WILL BE FULLY PROTECTED FROM DAMAGE. ANY DAMAGE RESULTING FROM A LACK OF ADEQUATE SHORING, BRACING OR SHEETING SHALL BE THE RESPONSIBILITY OF THE CONTRACTOR AND HE SHALL EFFECT NECESSARY REPAIRS OR RECONSTRUCTION AT HIS OWN EXPENSE. WHERE THE EXCAVATION FOR A CONDUIT TRENCH. STRUCTURE AND/OR BORING OR JACKING PIT IS FIVE FEET OR MORE IN DEPTH THE CONTRACTOR SHALL CONFORM TO THE APPLICABLE CONSTRUCTION SAFETY ORDERS OF THE DIVISION OF INDUSTRIAL SAFETY OF THE STATE OF CALIFORNIA. THE CONTRACTOR SHALL ALWAYS COMPLY WITH OSHA REQUIREMENTS.

CAL-OSHA NOTES

- 23. DURING CONSTRUCTION, THE CONTRACTOR SHALL BE RESPONSIBLE FOR THE PUBLIC SAFETY AND SAFETY OF EXISTING STRUCTURES. THE CONTRACTOR SHALL PROVIDE ADEQUATE BARRICADES, TRAFFIC CONTROLS, SHORINGS, BRACING AND GUYS IN ACCORDANCE WITH ALL NATIONAL, STATE SPECS, AND LOCAL SAFETY
- 24. ALL APPLICABLE PRODECURE AND REQUIREMENTS OF THE CALIFORNIA CONSTRUCTION AND GENERAL INDUSTRY SAFETY ORDERS. THE OCCUPATIONAL SAFETY AND HEALTH ACT, AND THE CONSTRUCTION SAFETY ACT SHALL BE MET.

CORROSIVITY NOTE

25. PRIOR TO THE ISSUANCE OF GRADING OR BUILDING PERMITS CHEMICAL TESTING OR REPRESENTATIVE BUILDING PAD SOILS SHALL BE SUBMITTED TO DETERMINE THE LEVEL OF CORROSION PROTECTION REQUIRED FOR STEEL

2. THE CONTRACTOR SHALL NOTIFY UNDERGROUND SERVICE ALERT AT (800) 227-2600, 48 HOURS PRIOR TO

- THAT ARFA.
- 4. THE CONTRACTOR SHALL EXPOSE AND CHECK INVERTS ON EXISTING SEWERS AND STORM DRAINS AND VERIFY
- 6. MANHOLE, WATER VALVE, METER BOX, AND CLEANOUT RIM ELEVATIONS, SHOWN OR NOT SHOWN HEREON, ARE APPROXIMATE ONLY. THE CONTRACTOR SHALL BE RESPONSIBLE FOR ADJUSTING THE RIMS AND COVERS TO THE FINISHED PAVEMENT GRADE.
- 7. IF APPLICABLE, IT SHALL BE THE RESPONSIBILITY OF THE CONTRACTOR TO COORDINATE ALL NECESSARY UTILITY RELOCATION WITH THE APPROPRIATE UTILITY COMPANIES.

SANITARY AND STORM SEWER CONSTRUCTION

9. ALL SEWER AND STORM DRAIN CONSTRUCTION SHALL PROCEED FROM THE DOWNSTREAM CONNECTION TO THE

DUST CONTROL

- INCLUDING PROVISIONS PERTAINING TO WATER CONSERVATION.
- 11. ALL MUD OR DIRT CARRIED OFF THE CONSTRUCTION SITE ONTO ADJACENT STREETS SHALL BE SWEPT EACH

- 14. EXISTING CURB AND SIDEWALK WITHIN THE PROJECT LIMITS DAMAGED OR DISPLACED. EVEN THOUGH NOT PROPOSED TO BE REMOVED. SHALL BE REPAIRED OR REPLACED EVEN IF DAMAGE OR DISPLACEMENT OCCURRED PRIOR TO ANY WORK PERFORMED BY THE CONTRACTOR.
- 15. THE CONTRACTOR SHALL PROVIDE FOR INGRESS AND EGRESS FOR PRIVATE PROPERTY ADJACENT TO THE WORK AREA THROUGHOUT THE PERIOD OF CONSTRUCTION.

STAKING

EXCAVATIONS/TRENCHES

22. EXCAVATIONS SHALL BE ADEQUATELY SHORED, BRACED AND SHEETED SO THAT THE EARTH WILL NOT SLIDE


- ORDINANCES.

AND CONCRETE MATERIALS USES FOR CONSTRUCTION.



Aliquot Associates, Inc. 1390 S. Main St. - Ste. 310 Walnut Creek, CA 94596 Telephone: (925) 476-2300 Fax: (925) 476-2350

Civil Engineers Traffic Engineers Surveyors

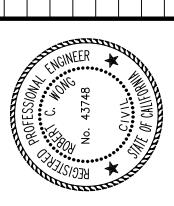

S

Ш 40 Ш

S

DRAWING NUMBER

DETAIL A - PERIMETER DRAINS NOT TO SCALE

-2'----6'---3'--| _EDGE OF EXCAVATION AND IMPERVIOUS LINER PLACE ROCK IN FRONT OF AND -12" THICK SPILLWAY OVER PIPE EVERY 8' TO ANCHOR PIPE. 2"x12" PRESSURE TREATED SPILLWAY, MAINTAIN LEVEL +3/4" HOLES OR 1/2" SLIT ON FACE/UNDERSIDE OF PIPE PLACED ÍN A 8"x8" PATTERN + 8" HDPE DRAINAGE SPREADER PIPE. LENGTH=40' —36" STAKES 2' O.C. ⊥INSTALL 6" NDS POP-UP EMITTER ON MIRAFI FW300 OR EQUAL — OVERFLOW -TOP OF SPREADER PIPE, 5FT. O/C. IMPERVIOUS LINER, 12" DIA. RIVER— COBBLES OR LIGHT RIPRAP 8" PVC FRONT FACE ONLY RISER W/ROUND LAP UNDER SPILLWAY PLASTIC GRATE COBBLE -CLEAN-OUT (TYP). __SPILLWAY 12" THICK BLANKET COBBLE UNDERLAIN WITH IMPERVIOUS LINER SECTION VIEW <u>PLAN VIEW</u>

DETAIL B - DISSIPATER NOT TO SCALE

1. PLACE AND EMBED COBBLE (NO DUMPING)

PRELIMINAR

ALIQUOT


Aliquot Associates, Inc. 1390 S. Main St. - Ste. 310 Walnut Creek, CA 94596

Telephone: (925) 476-2300 Fax: (925) 476-2350

Civil Engineers

Traffic Engineers

Surveyors

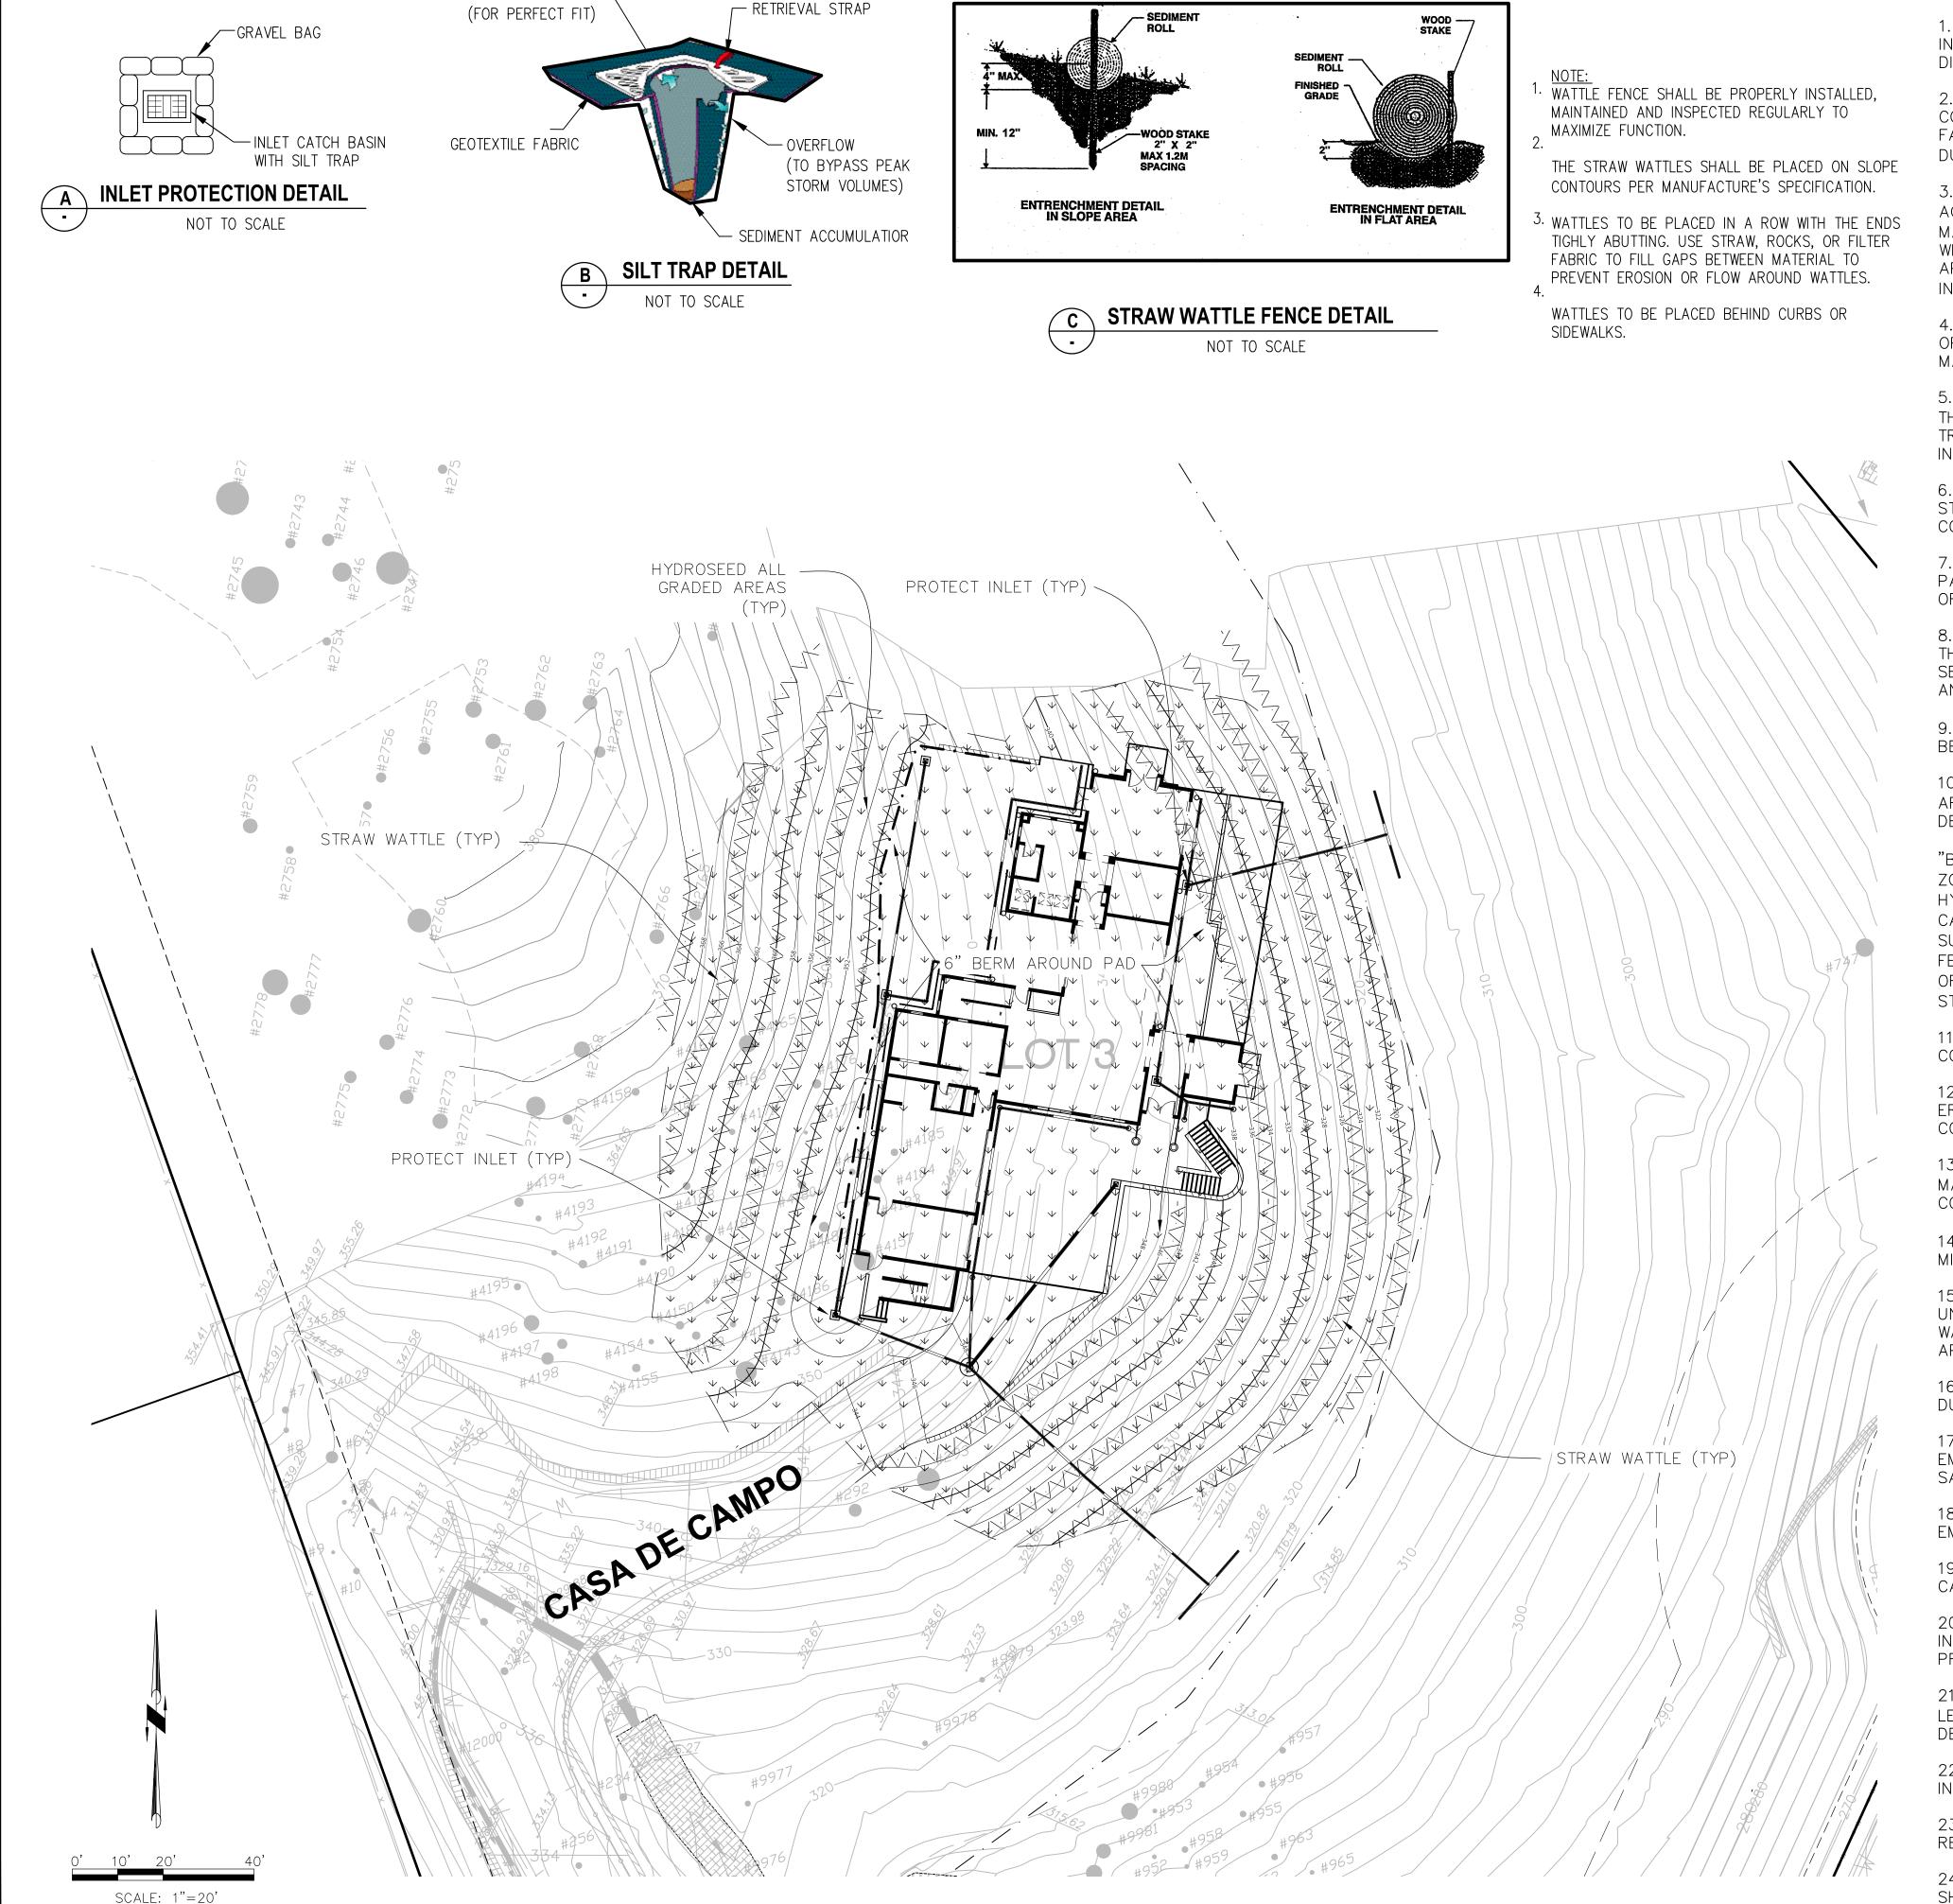

ADAPTER SKIRT -

EROSION CONTROL GENERAL NOTES:

TEMPORARY EROSION CONTROL MEASURES EFFECTIVE DURING RAINY SEASON-(OCTOBER I TO APRIL 15.)

1. TEMPORARY EROSION CONTROL MEASURE DEVICES SHOWN ON THE EROSION CONTROL PLAN WHICH INTEREFERE WITH THE WORK SHALL BE RELOCATED OR MODIFIED WHEN THE COUNTY INSPECTOR SO DIRECTS AS THE WORK PROGRESSES.

2. EXCEPT AS OTHERWISE DIRECTED BY THE COUNTY INSPECTOR, ALL DEVICES SHOWN ON THE EROSION CONTROL PLAN SHALL BE IN PLACE AT THE END OF EACH WORKING DAY. ALL EROSION CONTROL FACILITIES MUST BE INSPECTED AND REPAIRED BY THE CONTRACTOR AT THE END OF EACH WORKING DAY DURING THE RAINY SEASON (OCTOBER 1 TO APRIL 15).

3. ALL EROSION AND SEDIMENT CONTROL MEASURES SHALL BE CONSTRUCTED AND MAINTAINED IN ACCORDANCE WITH THE PROVISIONS OF THE ASSOCIATION OF BAY AREA GOVERNMENTS (ABAG) "A MANUAL OF STANDARDS FOR EROSION AND SEDIMENT CONTROL MEASURES" UNLESS OTHERWISE STATED WITHIN THESE GENERAL NOTES. EROSION CONTROL MEASURES ARE SUBJECT TO THE INSPECTION AND APPROVAL OF THE COUNTY BUILDING DEPARTMENT, GRADING SECTION. SCHEDULE AN EROSION CONTROL INSPECTION BY CALLING (925) 335-1123 AT LEAST 48 HOURS PRIOR TO THE START OF ANY WORK.

4. ALL LOOSE SOILS AND DEBRIS SHALL BE REMOVED FROM THE STREET AREAS UPON STARTING OPERATIONS AND PERIODICALLY THEREAFTER AS DIRECTED BY THE INSPECTOR. THE SITE SHALL BE MAINTAINED SO AS TO MINIMIZE SEDIMENT LADEN RUNOFF TO ANY STORM DRAIN SYSTEM.

5. THE CONTRACTOR SHALL PLACE DRAIN ROCK AS A GRAVEL ROADWAY (6" MINIMUM THICKNESS FOR THE FULL WIDTH AND 50 FEET LONG) AT EACH ROAD ENTRANCE TO THE SITE. ANY MUD THAT IS TRACKED ONTO PUBLIC STREETS SHALL BE REMOVED THE SAME DAY AS REQUIRED BY THE COUNTY INSPECTOR. TEMPORARY ENTRANCES WILL BE ON BOULEVARD WAY.

6. AFTER OCTOBER 1, ALL EROSION CONTROL MEASURES WILL BE INSPECTED DAILY AND AFTER EACH STORM. AFTER OCTOBER 1, BREACHES IN DIKES, STRAW WATTLES OR OTHER EROSION AND SEDIMENT CONTROL FACILITIES WILL BE REPAIRED AT THE CLOSE OF EACH DAY AND WHENEVER RAIN IS FORECAST.

7. ALL GRADED AREAS, INCLUDING, BUT NOT LIMITED TO, CUT AND FILL SLOPES, ROADS, AND BUILDING PADS SHALL BE HYDROSEEDED. IN ADDITION TO HYDROSEEDING, APPLICATION OF STRAW WITH A TACKIFIER OR MULCH MAY BE REQUIRED BY THE COUNTY INSPECTOR.

8. IF ANY GRADING OPERATIONS, OTHER THAN LOT FINISH GRADING, ARE TO BE PERFORMED DURING THE RAINY SEASON, OCTOBER 1 THROUGH APRIL 15, AN EROSION CONTROL PLAN MUST BE SUBMITTED BY SEPTEMBER 1 AND THE PLAN MUST BE APPROVED BY THE COUNTY PRIOR TO THE COMMENCEMENT OF ANY SUCH GRADING OPERATIONS.

9. ALL CUT AND FILL SLOPES ARE TO BE PROTECTED TO PREVENT OVERBANK FLOW USING 4" EARTH BERMS OR SILT FENCES.

10. ALL GRADED AREAS, INCLUDING, BUT NOT LIMITED TO, CUT AND FILL SLOPES, STREETS, PARKING AREAS, AND BUILDING PADS SHALL BE HYDROSEEDED PER COUNTY'S REQUIREMENT. SUGGESTED MIX DESIGN FOLLOWS:

"BLANDO BROME" 40 LBS./ACRE ZORRO FESCUE 10 LBS./ACRE 5 LBS./ACRE HYKON ROSE CLOVER CALIFORNIA NATIVE WILDFLOWER 8 LBS./ACRE SUB-COVER 9 LBS./ACRE FERTILIZER 100 LBS./ACRE ORGANIC BINDER 300 LBS./ACRE STRAW MULCH 4000 LBS./ACRE

11. BORROW AREAS AND TEMPORARY STOCKPILES SHALL BE PROTECTED WITH APPROPRIATE EROSION CONTROL MEASURES TO THE SATISFACTION OF THE COUNTY INSPECTIOR.

12. SANDBAGS OR STRAW BALES SHALL BE STOCKPILED ON SITE AND PLACED AT INTERVALS SHOWN ON EROSION CONTROL PLANS, WHEN THE RAIN FORECAST IS 40% OR GREATER, OR WHEN DIRECTED BY THE COUNTY INSPECTOR.

13. SANDBAGS REFERRED TO IN THE PRECEDING ITEMS MUST BE FULL. APPROVED SANDBAG FILL MATERIALS ARE DECOMPOSED GRANITE AND/OR GRAVEL, OR OTHER MATERIALS APPROVED BY THE COUNTY INSPECTOR.

14. ALL CATCH BASIN & INLETS PRIOR TO PAVING WILL BE EQUIPPED WITH WATTLE BARRIER PLACED 2" MIN. BELOW TOP OF GROUND LEVEL.

15. THIS PLAN MAY NOT COVER ALL THE SITUATIONS THAT ARISE DURING CONSTRUCTION DUE TO UNANTICIPATED FIELD CONDITIONS OR IN EXTREME STORM CONDITIONS THE CONTRACTOR MAY USE STRAW WATTLES, SAND BAGS TO SECURE THESE EROSION CONTROL MEASURES AND VARIATIONS WITH THE APPROVAL OF COUNTY INSPECTOR.

16. THE CONTRACTOR SHALL HAVE A COMPREHENSIVE PROGRAM FOR INSPECTION AND MAINTENANCE DURING WINTER SEASON, INCLUDING PROVISION FOR DOCUMENTING MAINTENANCE ACTIVITIES.

17. THE CONTRACTOR CAN STORE TEMPORARILY STOCKPILES AND EROSION CONTROL SUPPLIES TO HANDLE EMERGENCIES, AND SHALL BE PROTECTED WITH APPROPRIATE EROSION CONTROL MEASURES TO THE SATISFACTION OF THE COUNTY INSPECTOR.

18. THE CONTRACTOR SHALL KEEP AN EMERGENCY PHONE NUMBER OF CREW CAPTAIN THAT WILL HANDLE EMERGENCIES.

19. THE CONTRACTOR SHALL ASSIGNED STAND-BY CREWS 24 HOURS SEVEN DAYS PER WEEK TO BE CALLED TO WORK DURING EACH RAINSTORM EMERGENCY.

20. THE CONTRACTOR SHALL ASSIGN ONE CREW CAPTAIN RESPONSIBLE FOR DAILY, WEEKLY, MONTHLY INSPECTION DURING WET, AND DRY WEATHER TO BE SURE ALL EROSION CONTROL MEASURES ARE WORKING PROPERLY AND RECORD THEIR INSPECTIONS ESPECIALLY AFTER EACH STORM IN A LOG.

21. SEDIMENT TRAPS SHALL BE CLEANED OUT WHENEVER SEDIMENT REACHES THE SEDIMENT CLEAN OUT LEVEL INDICATED ON DETAIL 7 ON THIS SHEET. IT IS THE CONTRACTOR'S RESPONSIBILITY TO CLEAN THE DESILTING BASINS AND THE SEDIMENT TRAPS.

22. EROSION CONTROL STRUCTURES SHALL BE ADJUSTED BY THE CONTRACTOR TO REFLECT ALL CHANGES IN DRAINAGE AS ROAD IS BEING INSTALLED.

23. STOCKPILES OF TRENCH SPOILS, DEBRIS, SOIL, SAND OR OTHER MATERIALS SHALL BE COVERED OR REMOVED AS SOON AS PRACTICAL.

24. TEMPORARY STOCKPILES OF SUPPLIES ON SITE NECESSARY TO HANDLE EMERGENCY FIELD CONDITION SHALL BE PROTECTED WITH APPROPRIATE EROSION CONTROL MEASURES & COVERED TO THE SATISFACTION OF THE COUNTY INSPECTOR.

ALIQUOT

Aliquot Associates, Inc. 1390 S. Main St. - Ste. 310 Walnut Creek, CA 94596 Telephone: (925) 476-2300 Fax: (925) 476-2350

Civil Engineers Traffic Engineers Surveyors

Io. BY DATE REVISIONS

PROFESSOM No. 43748 No. 43748

IFORNIA


AKS

N CONTROL PLAN LOT 3 AMPO-CREEKSIDE OA

5 CASA DE CAMF

KC KC KC CONT

DRAWING NUMBER

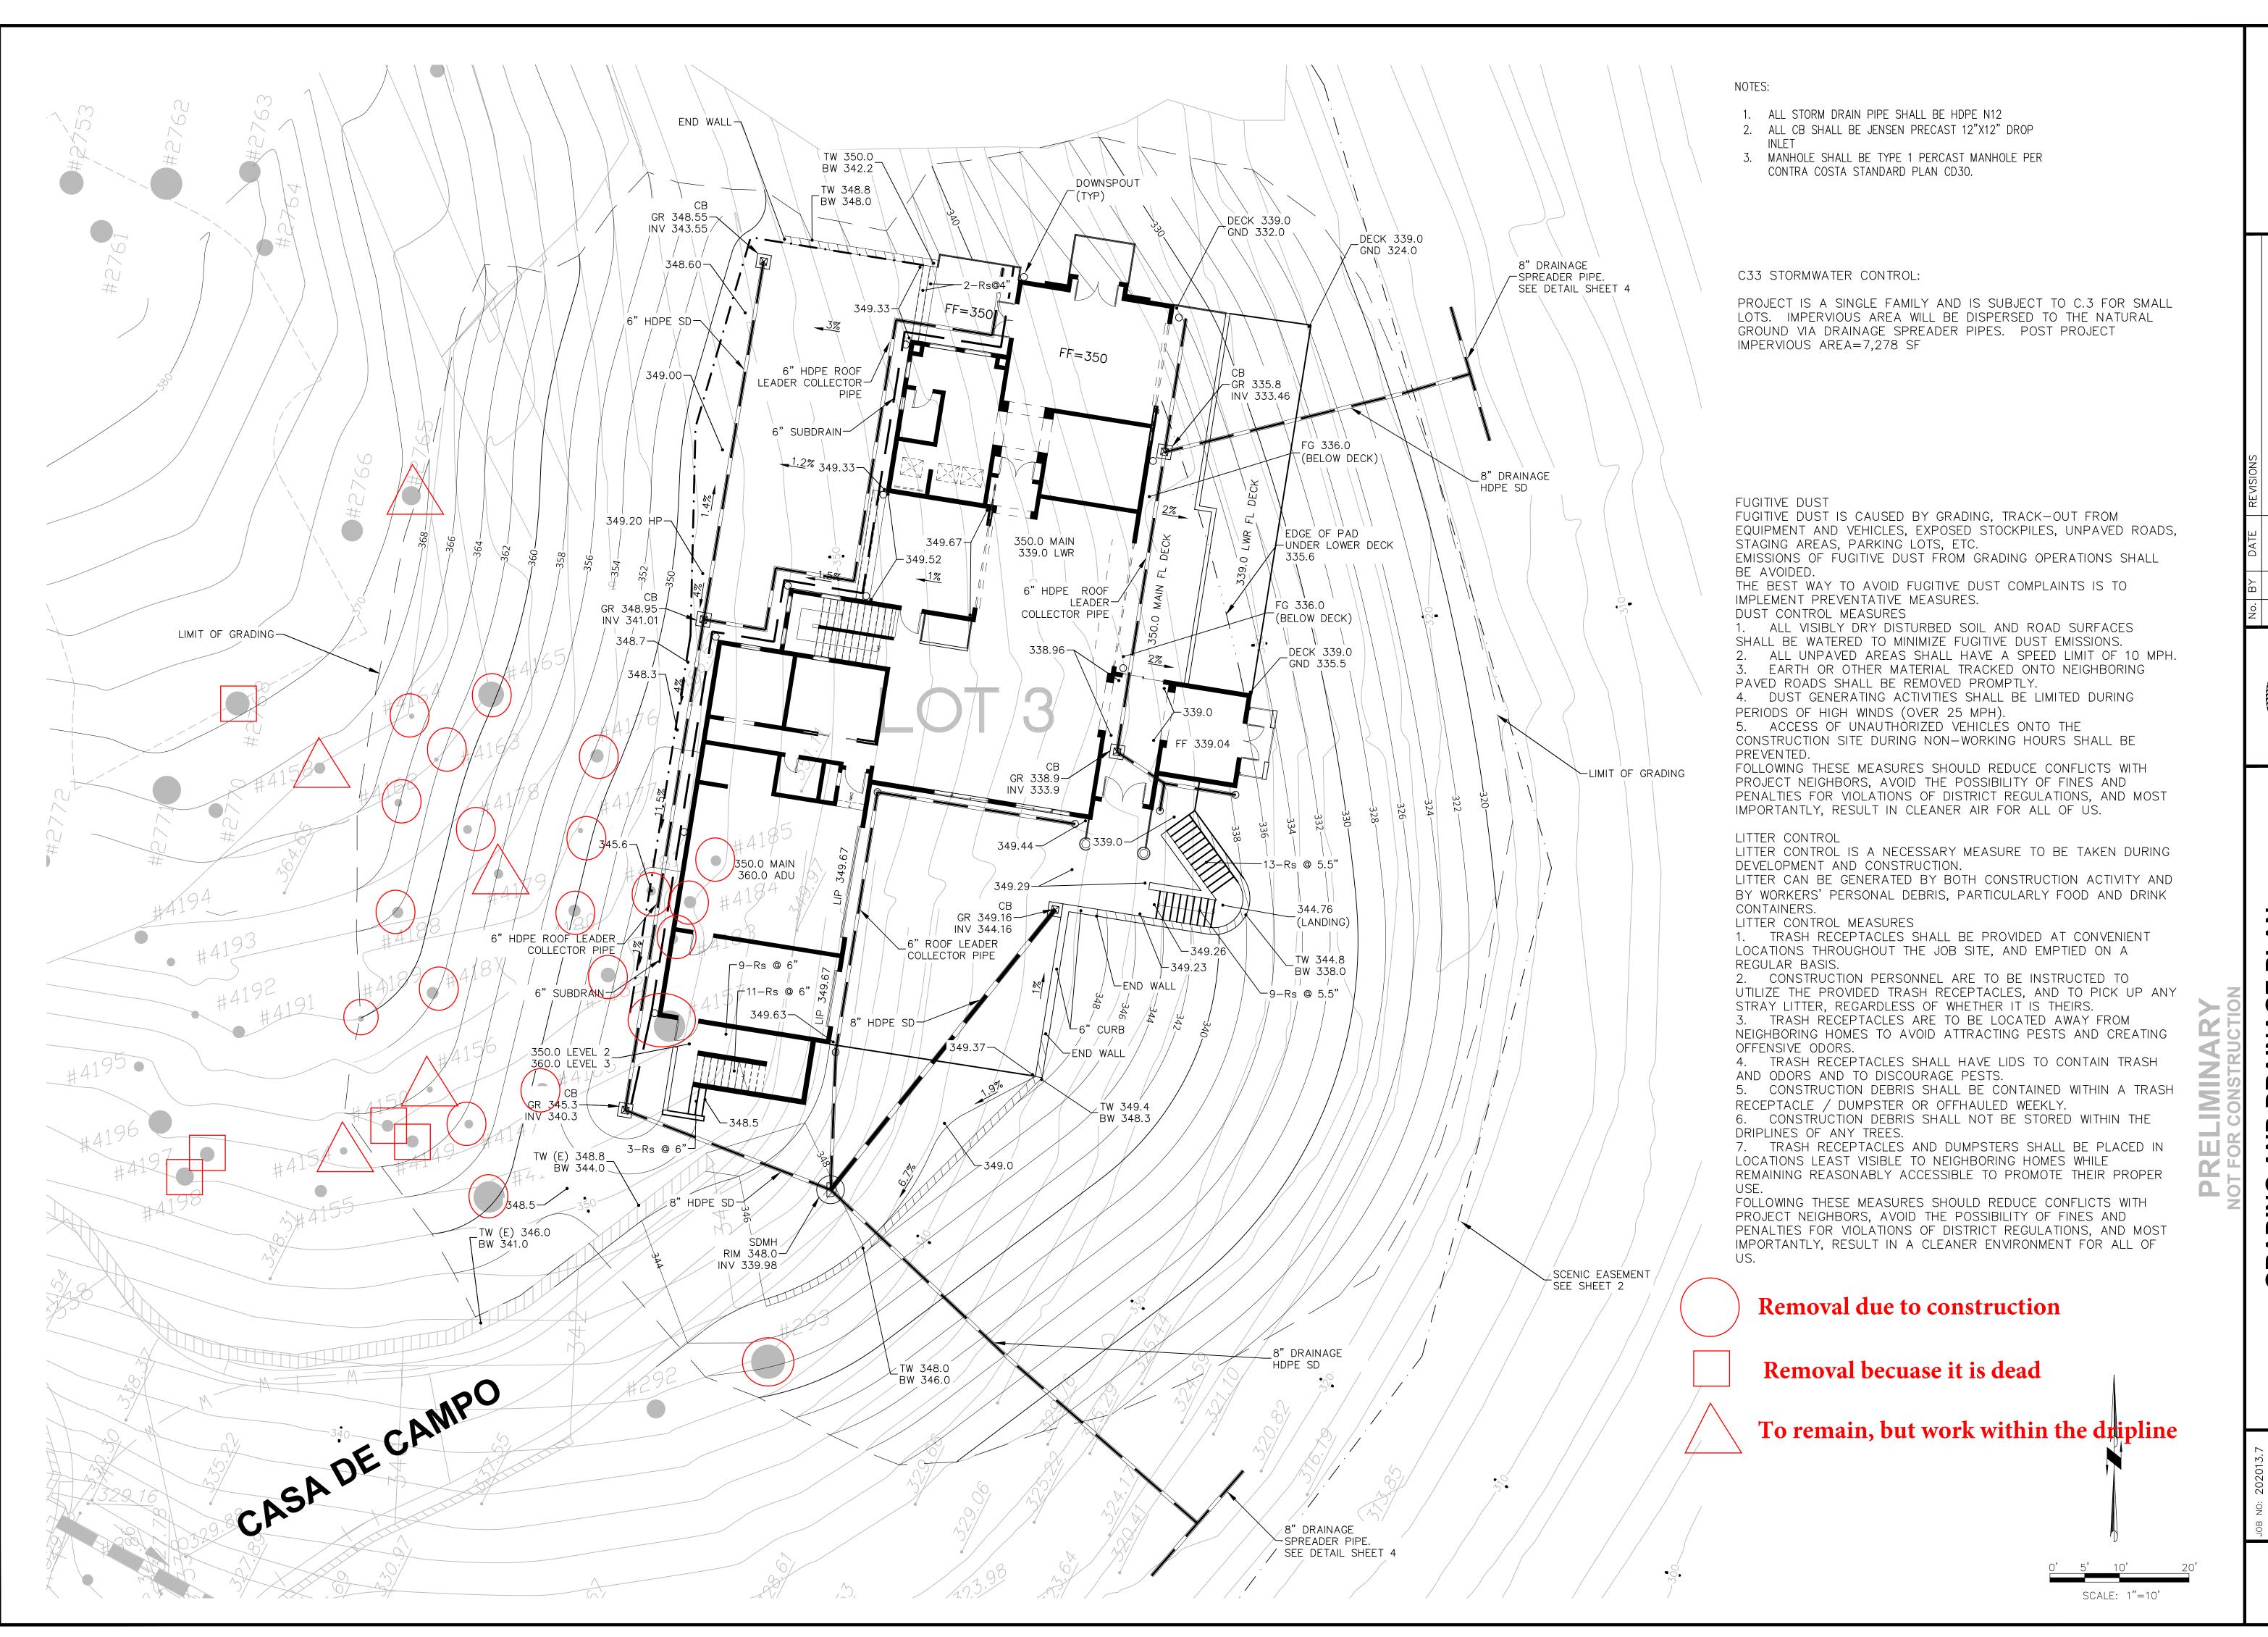

ALIQUOT

Aliquot Associates, Inc. 1390 S. Main St. - Ste. 310 Walnut Creek, CA 94596 Telephone: (925) 476-2300 Fax: (925) 476-2350

Civil Engineers Traffic Engineers Surveyors

DR

DRAWING NUMBER

