

1ST FLOOR PLAN


GROUND FLOOR PLANW/PATIO LOCATIONS

DATE: 7/15/2019 SCALE: 1/4"=1'-0"

DRAWN:

SHEET <u>A — 2</u>


SHEETS

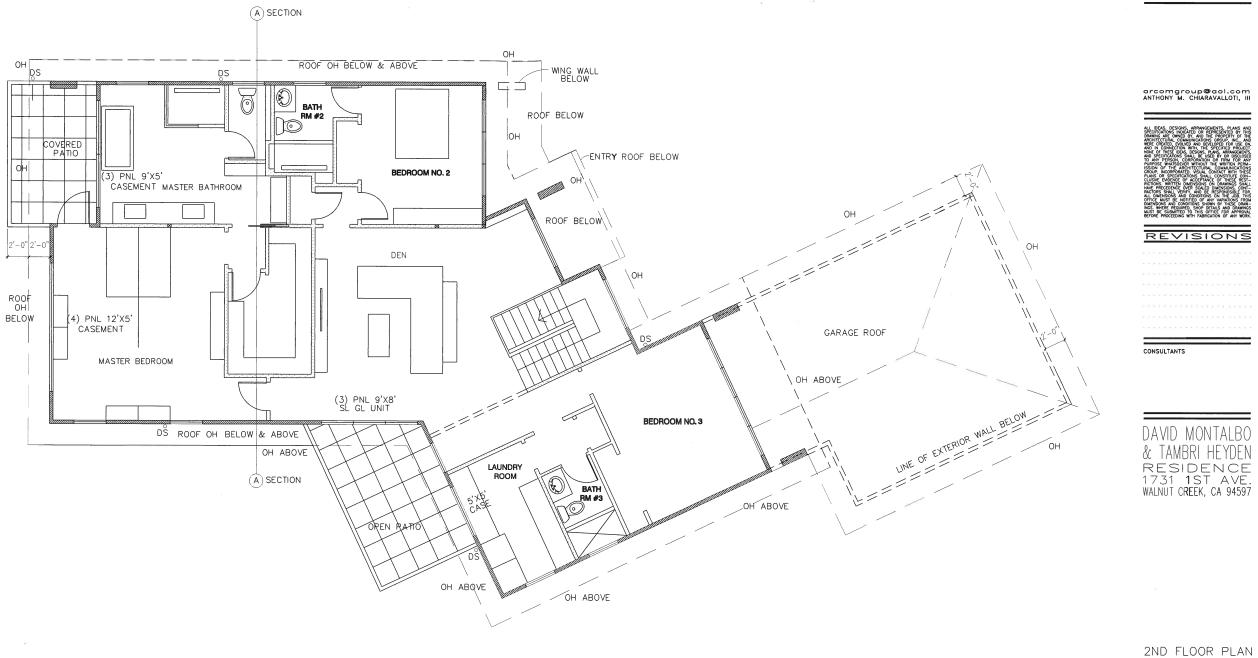

SECOND FLOOR PLAN WITH ROOF & PATIO LOCATIONS

DATE: 7/15/2019

SCALE: 1/4"=1'-0"

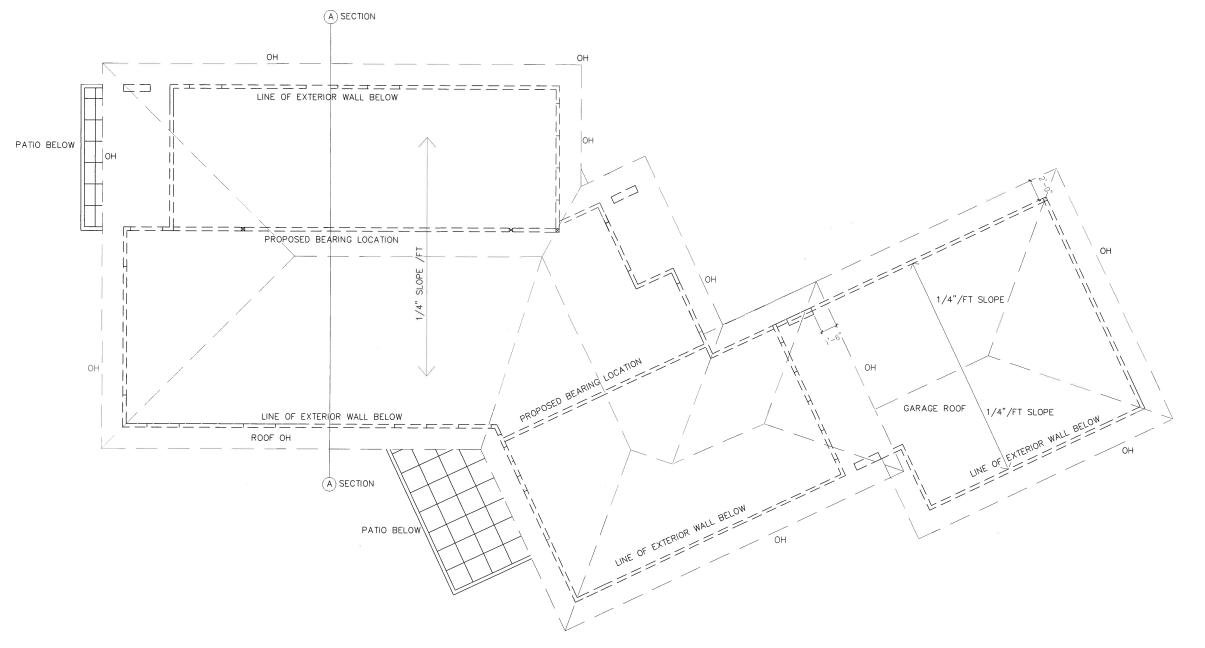

arcomgroup@aol.com ANTHONY M. CHIARAVALLOTI,



REVISION

CONSULTA

DAVID MONTALBO & TAMBRI HEYDEN RESIDENCE 1731 1ST AVE. WALNUT CREEK, CA 94597

2ND FLOOR ROOF PLAN

SECOND FLOOR ROOF PLAN WITH PATIO LOCATIONS BELOW


DATE: 7/15/2019


SCALE: 1/4"=1'-0"

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SHEETS



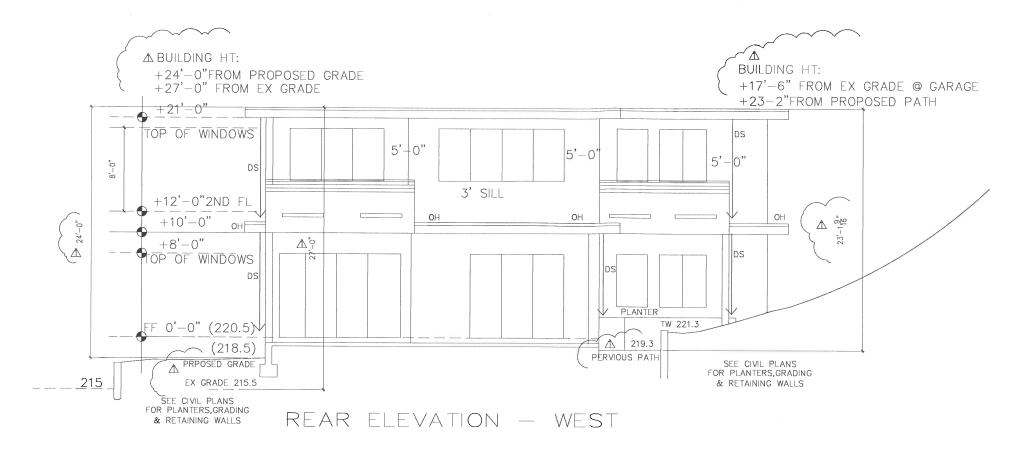

arcomgroup@aol.com ANTHONY M. CHIARAVALLOTI, III

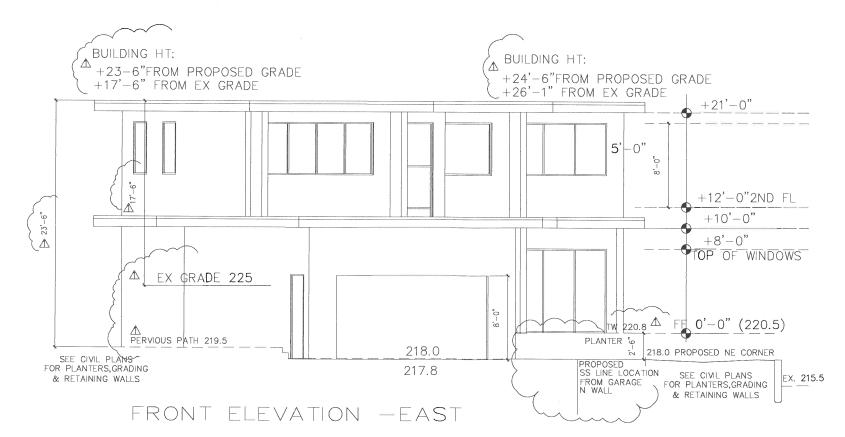

REVISIONS 10/3/2019

CONSULTANTS

DAVID MONTALBO & TAMBRI HEYDEN RESIDENCE 1731 1ST AVE. WALNUT CREEK, CA 94597

ELEVATIONS & NOTES

DATE: 7/15/2019


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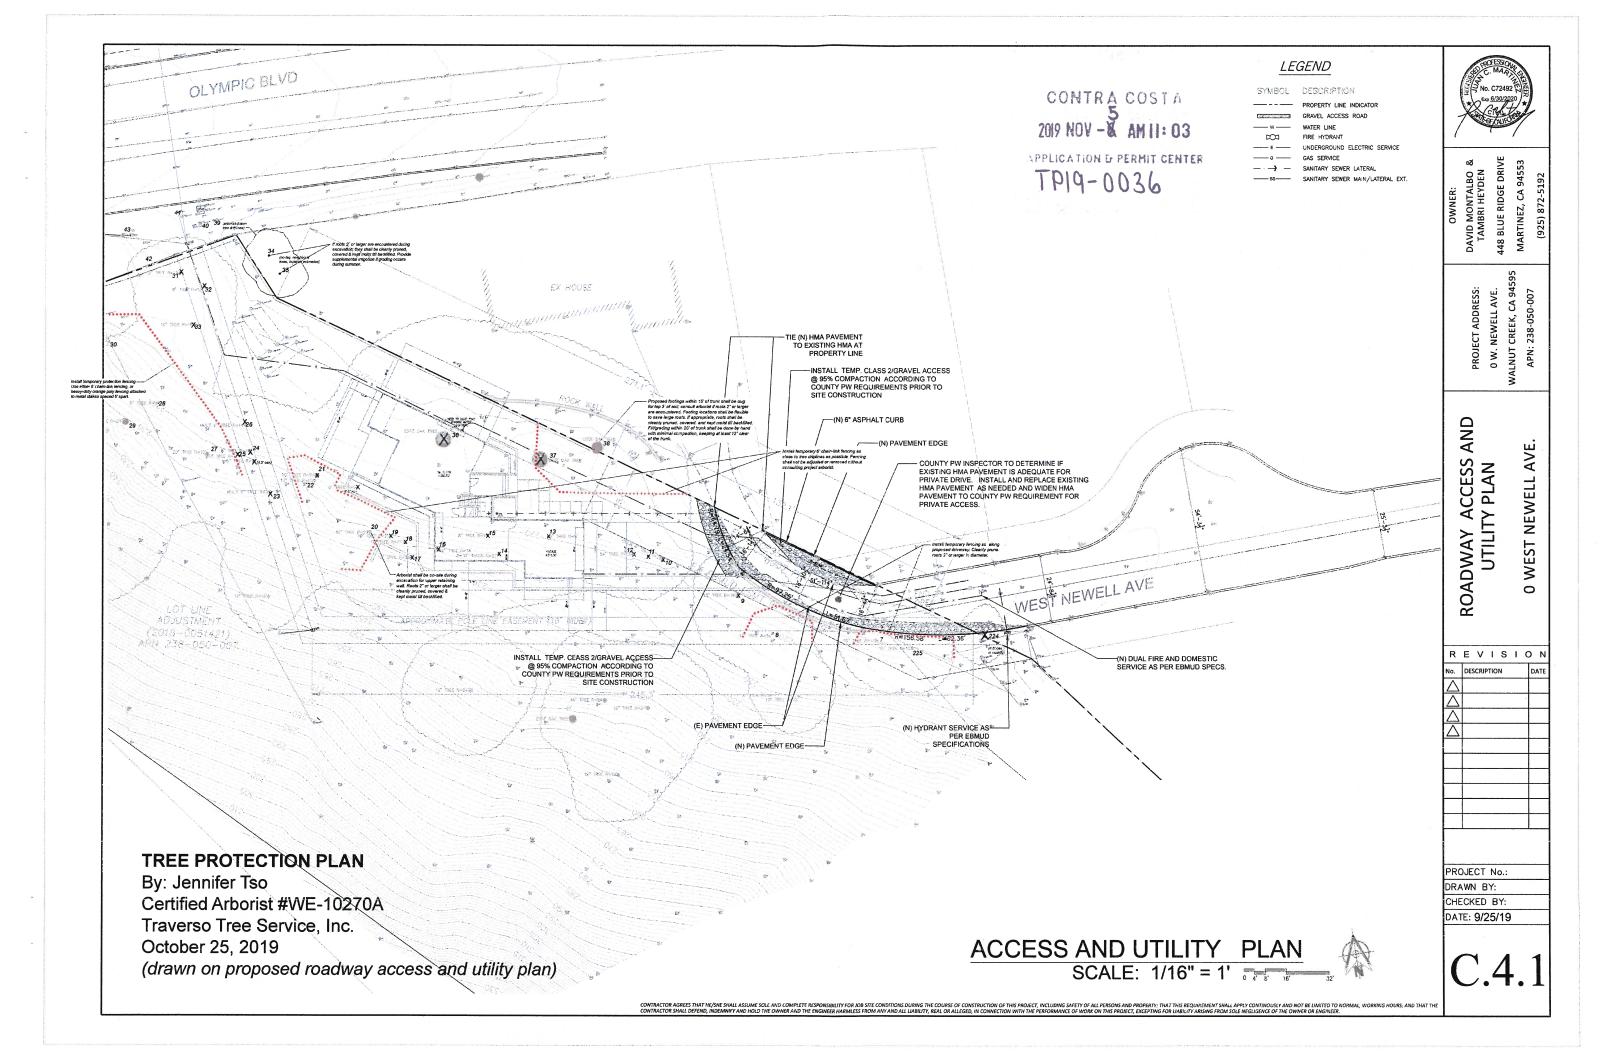
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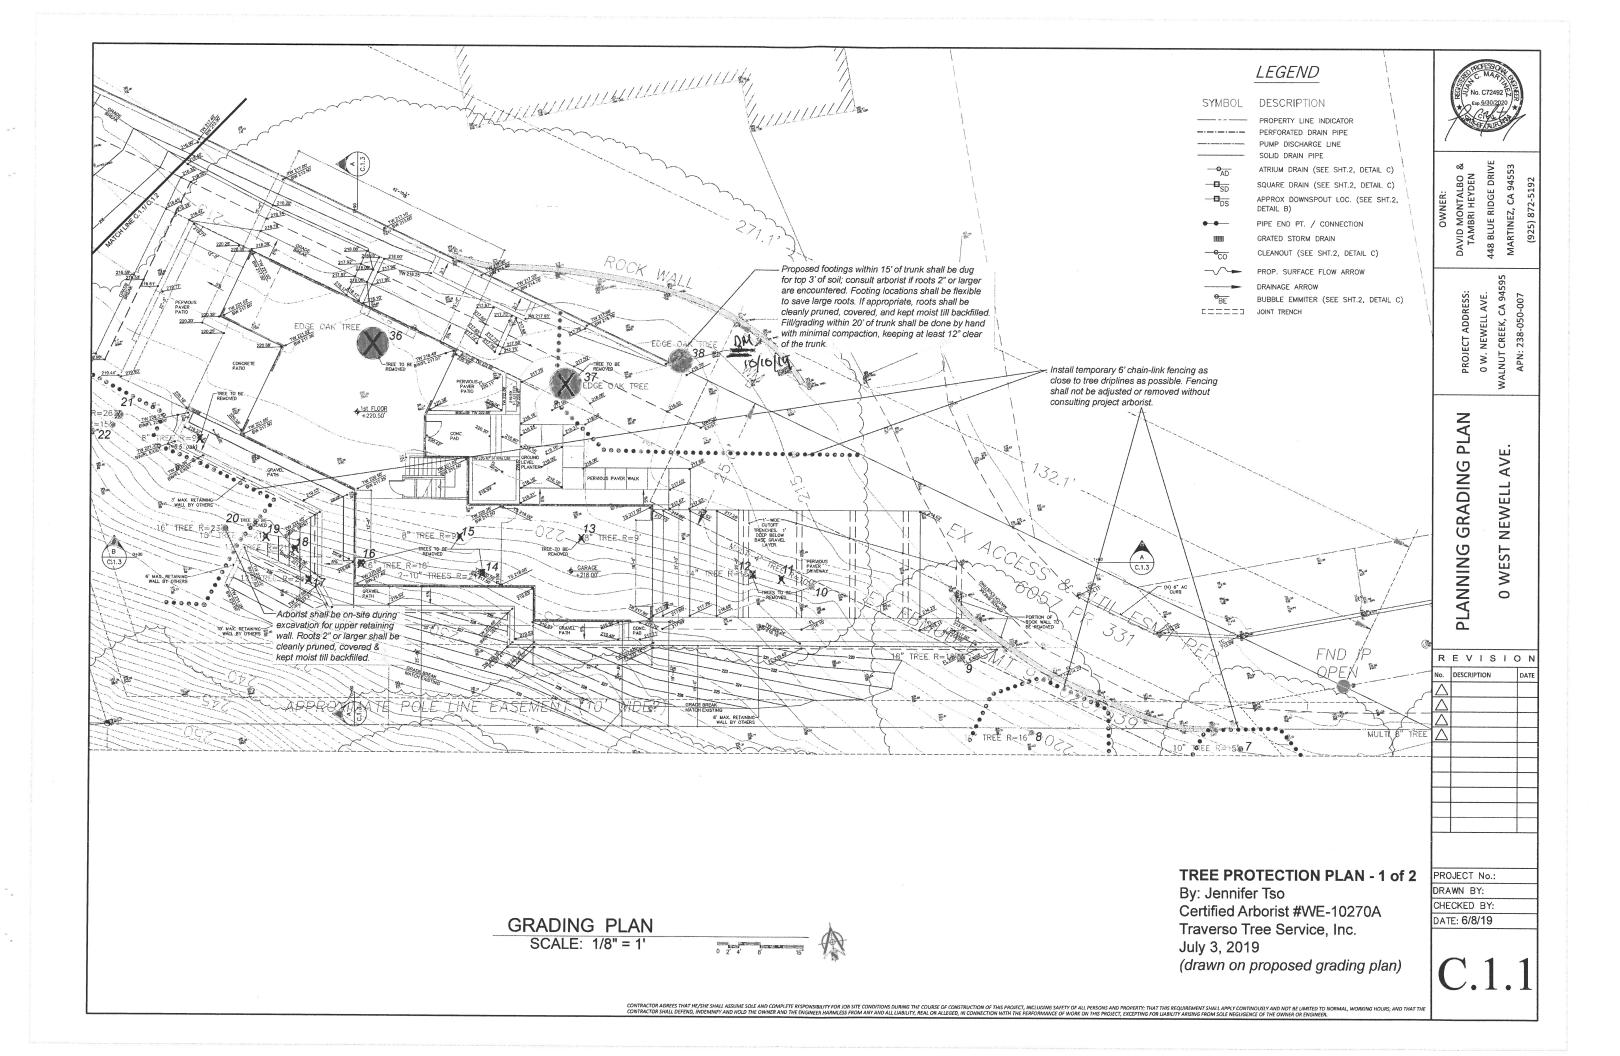
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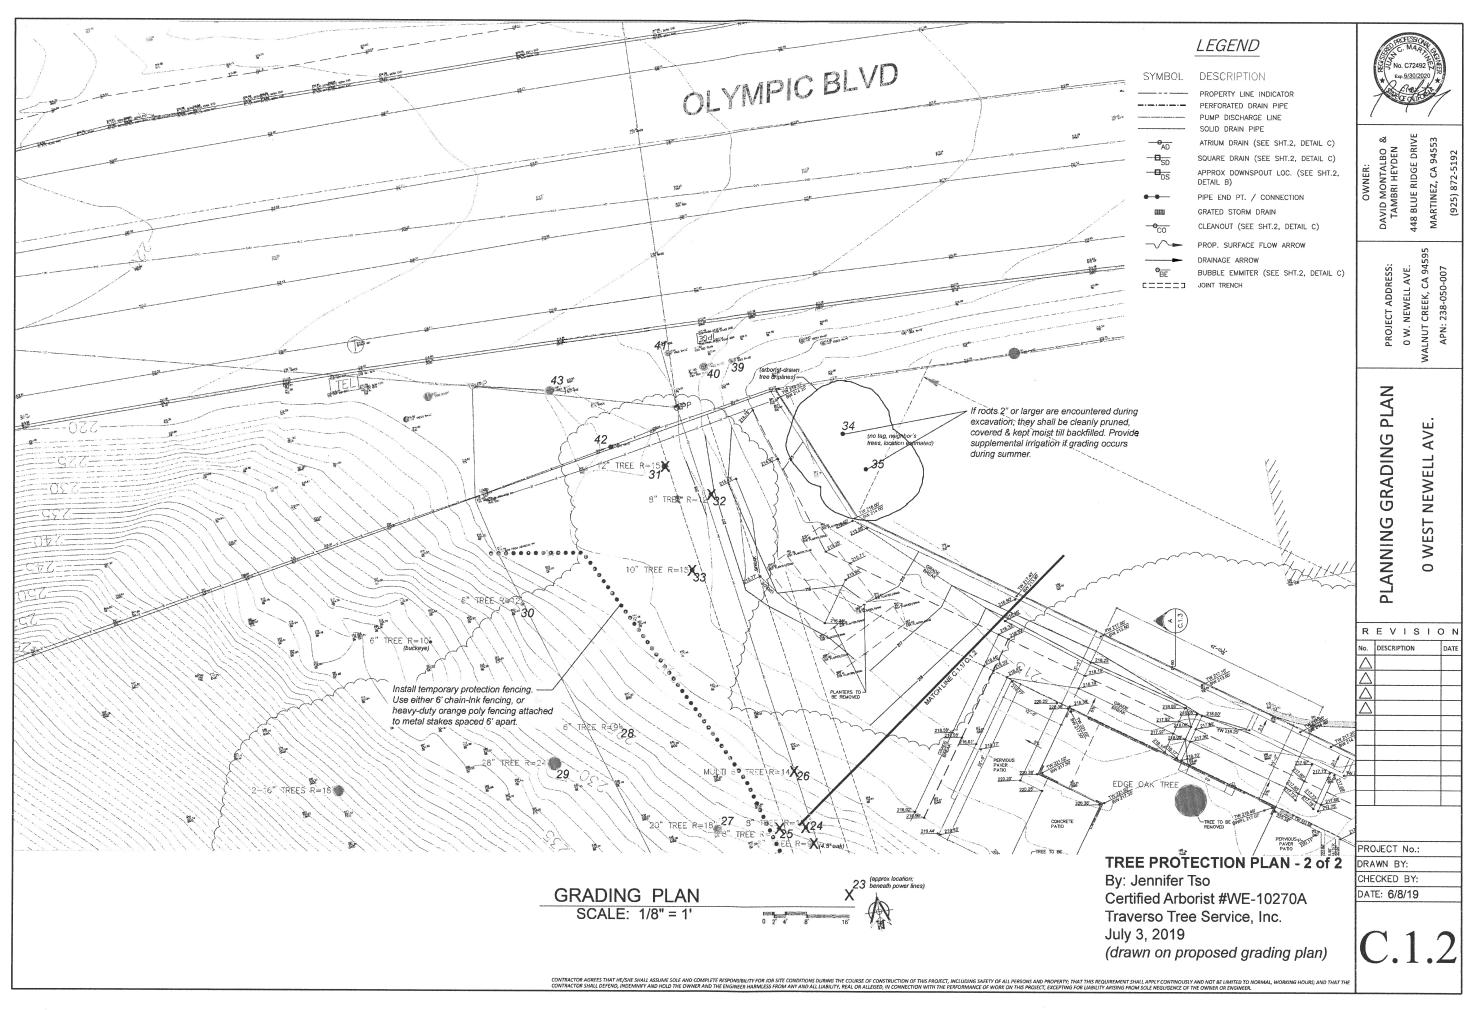
SHEET A


F SHEETS









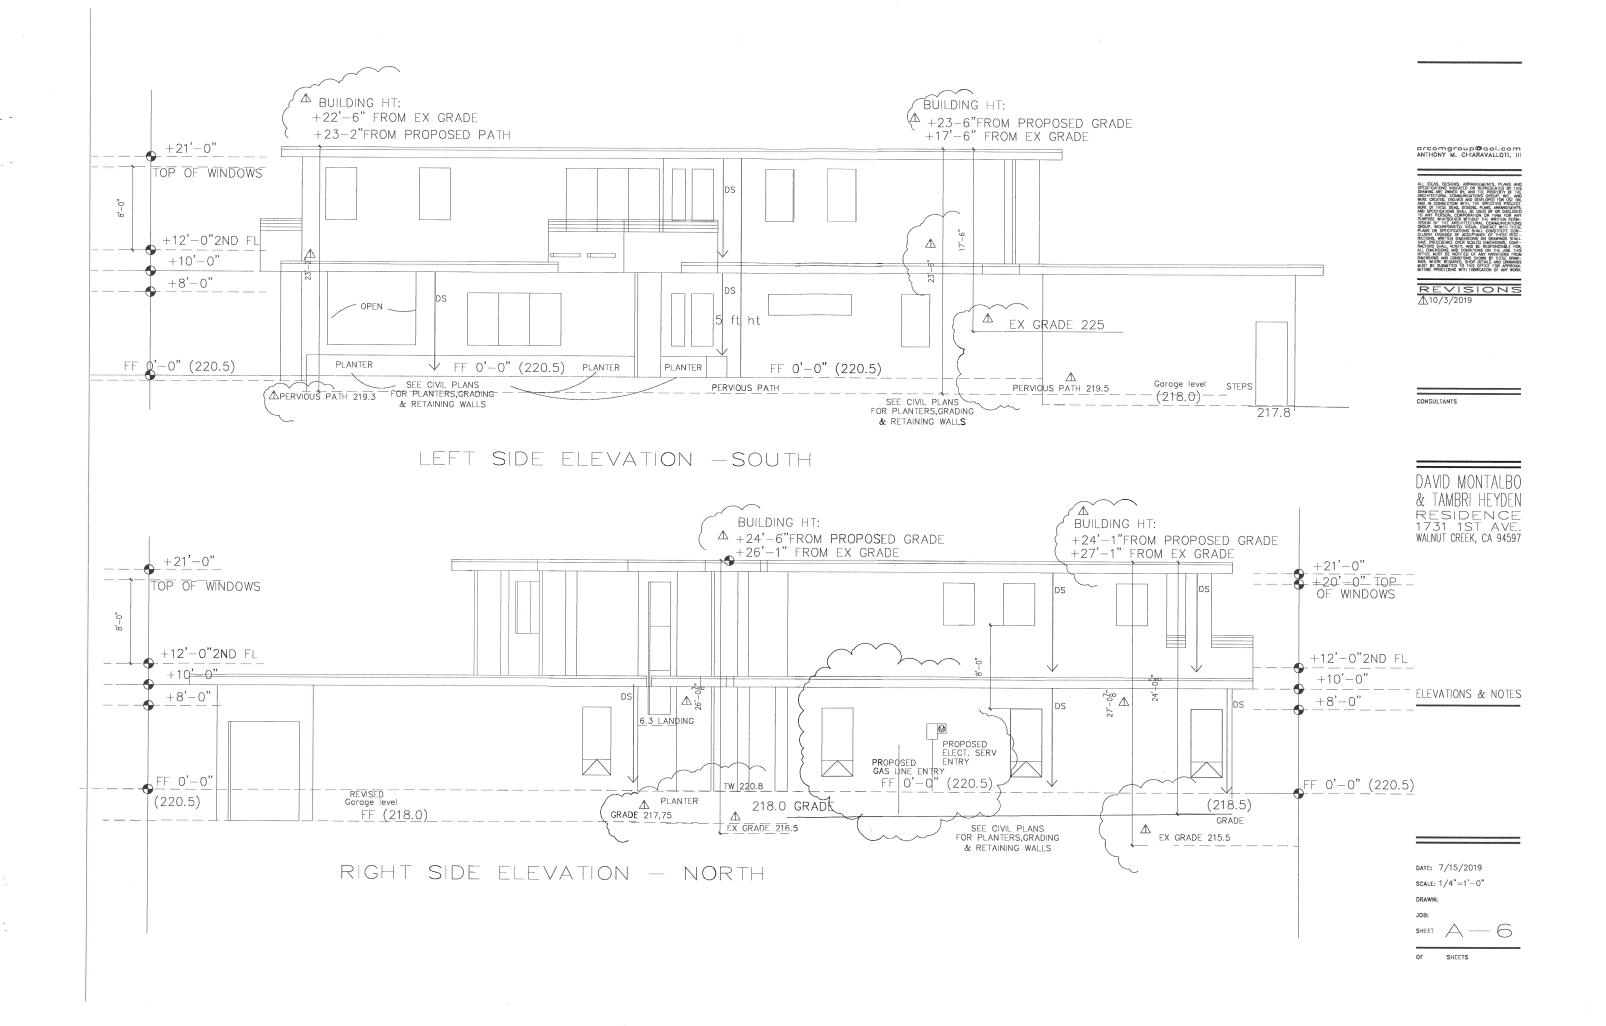


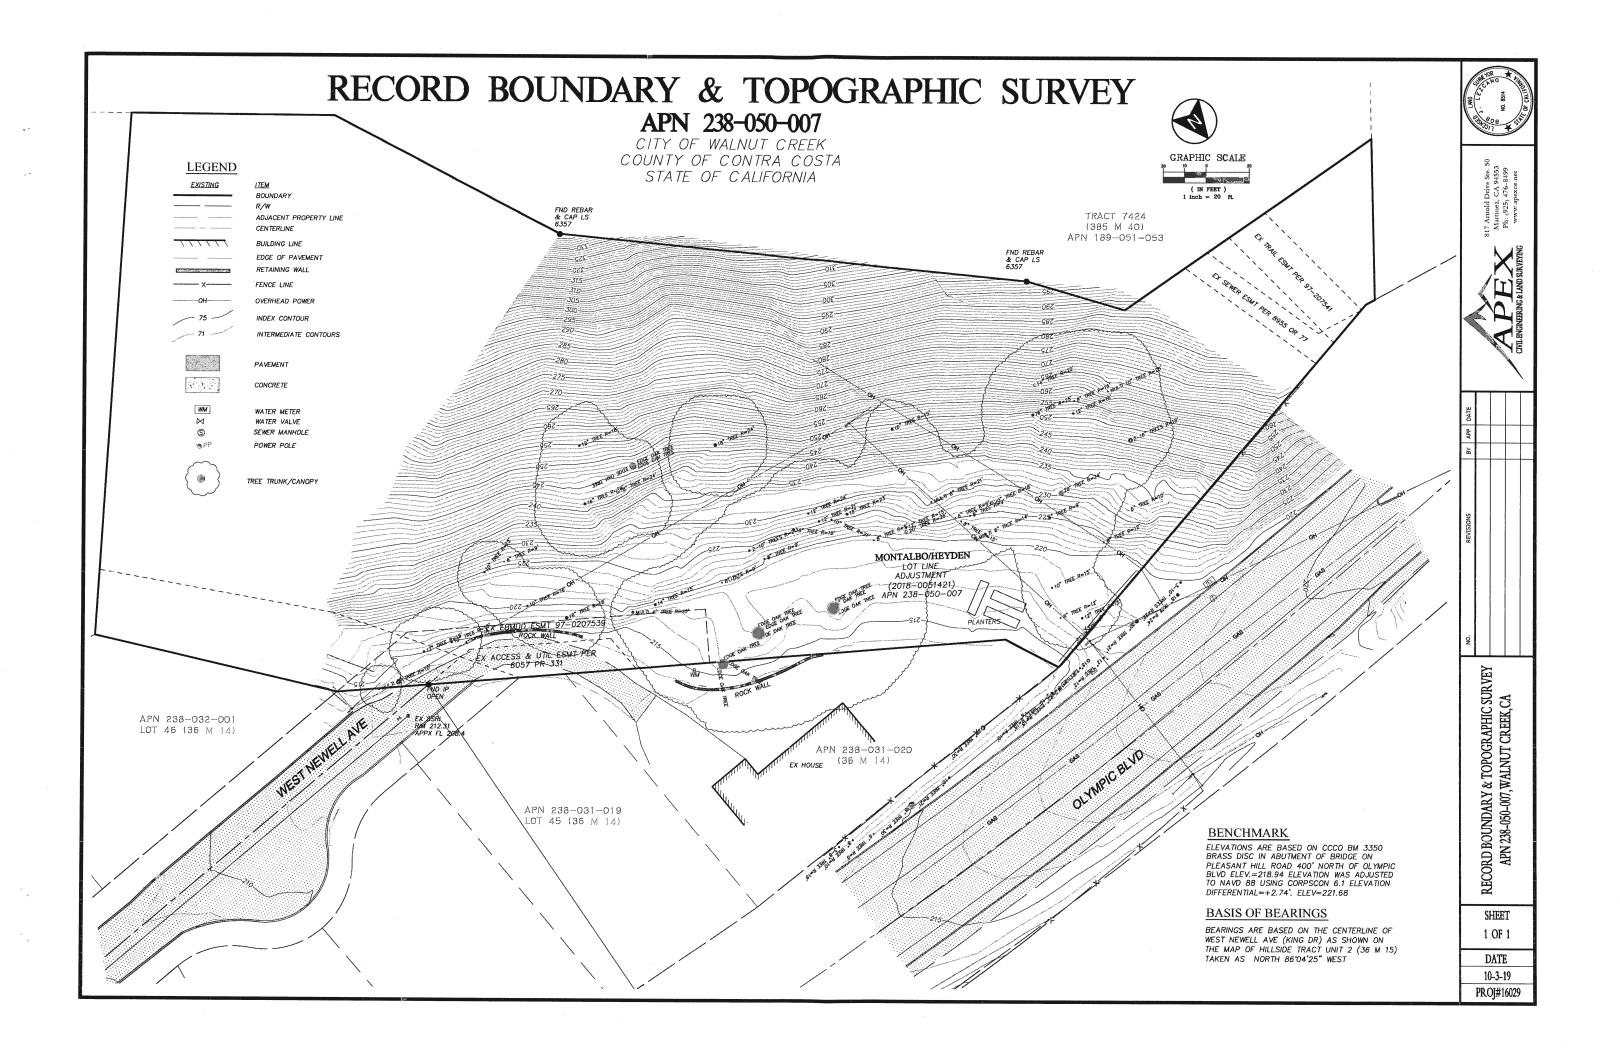

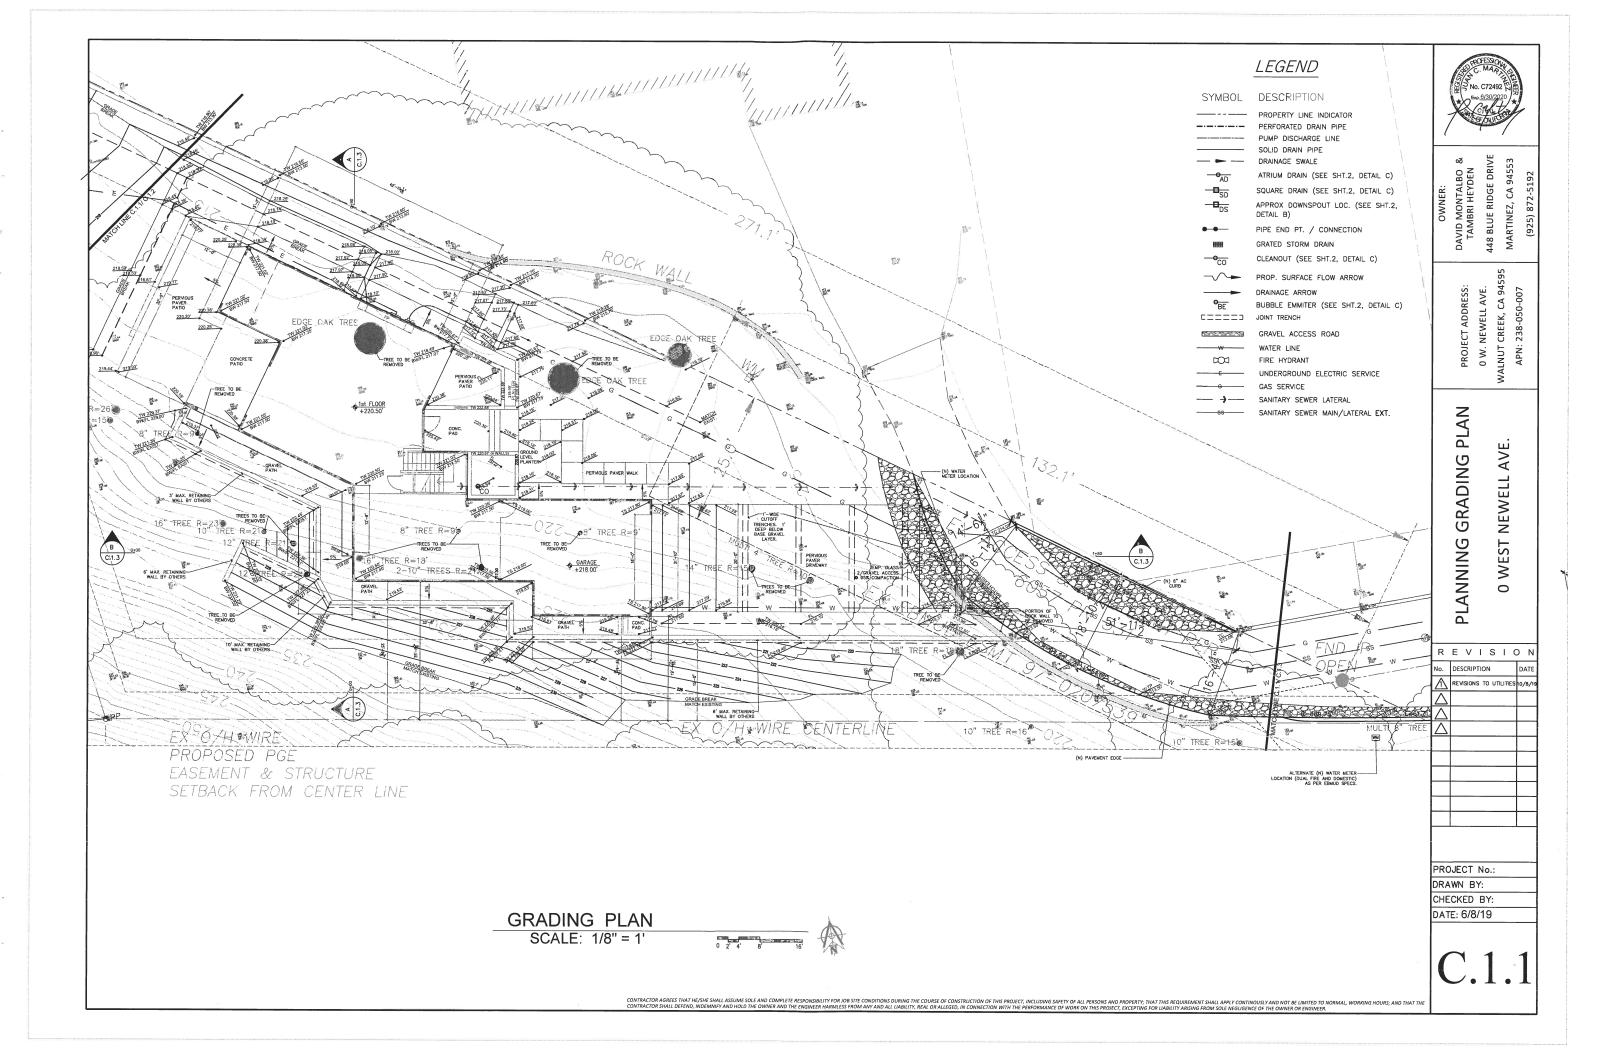

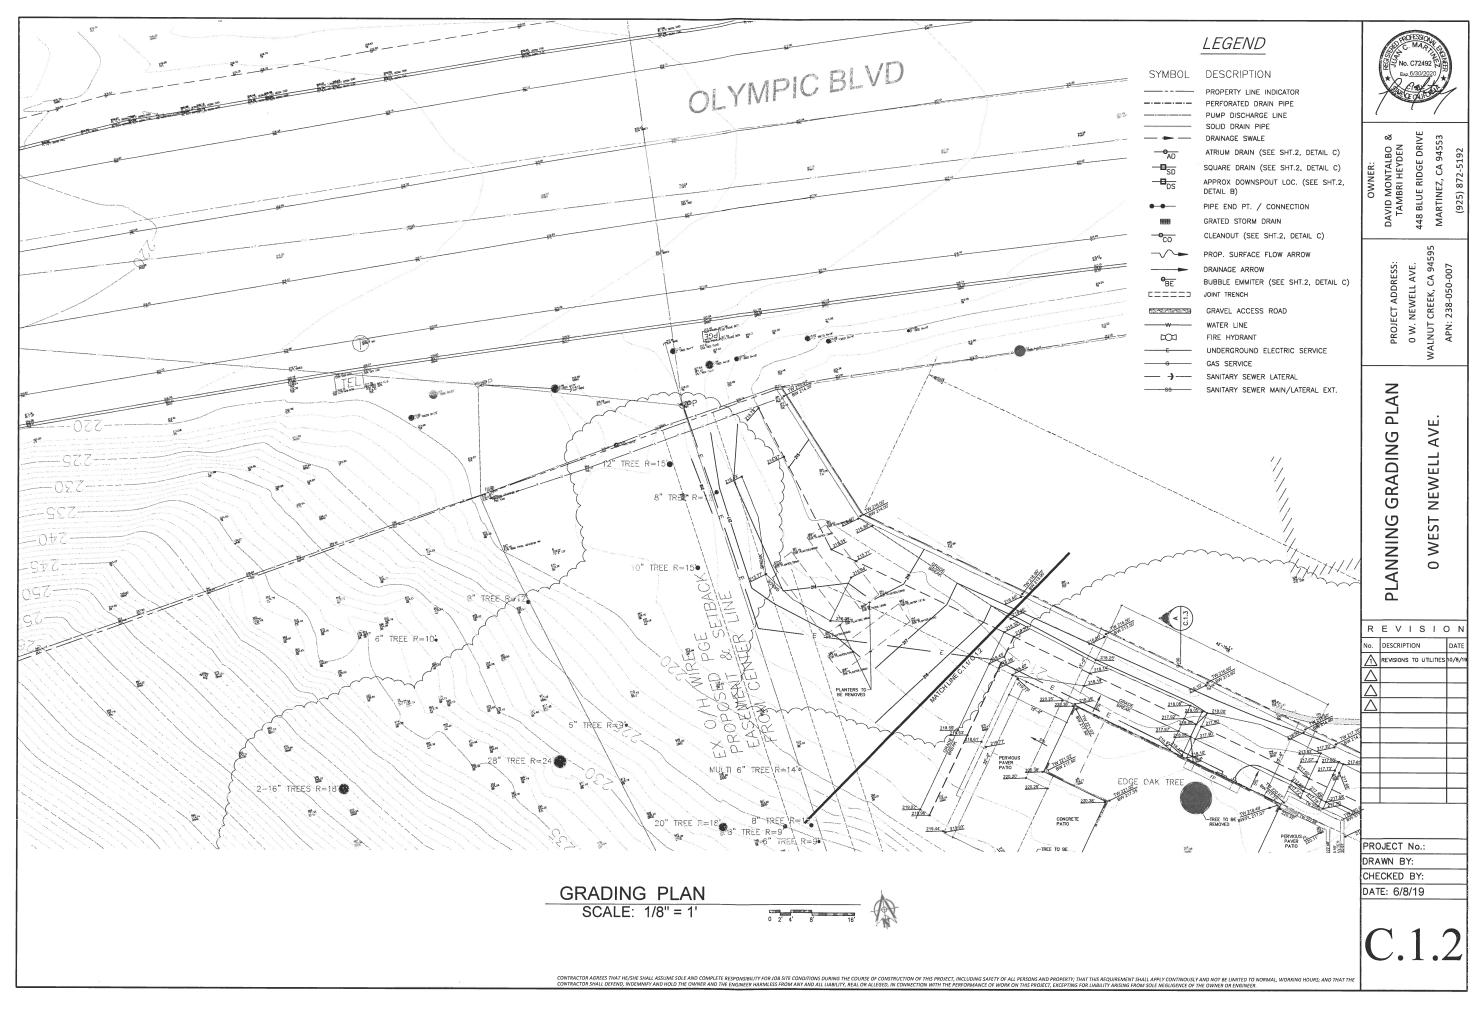

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LEGEND

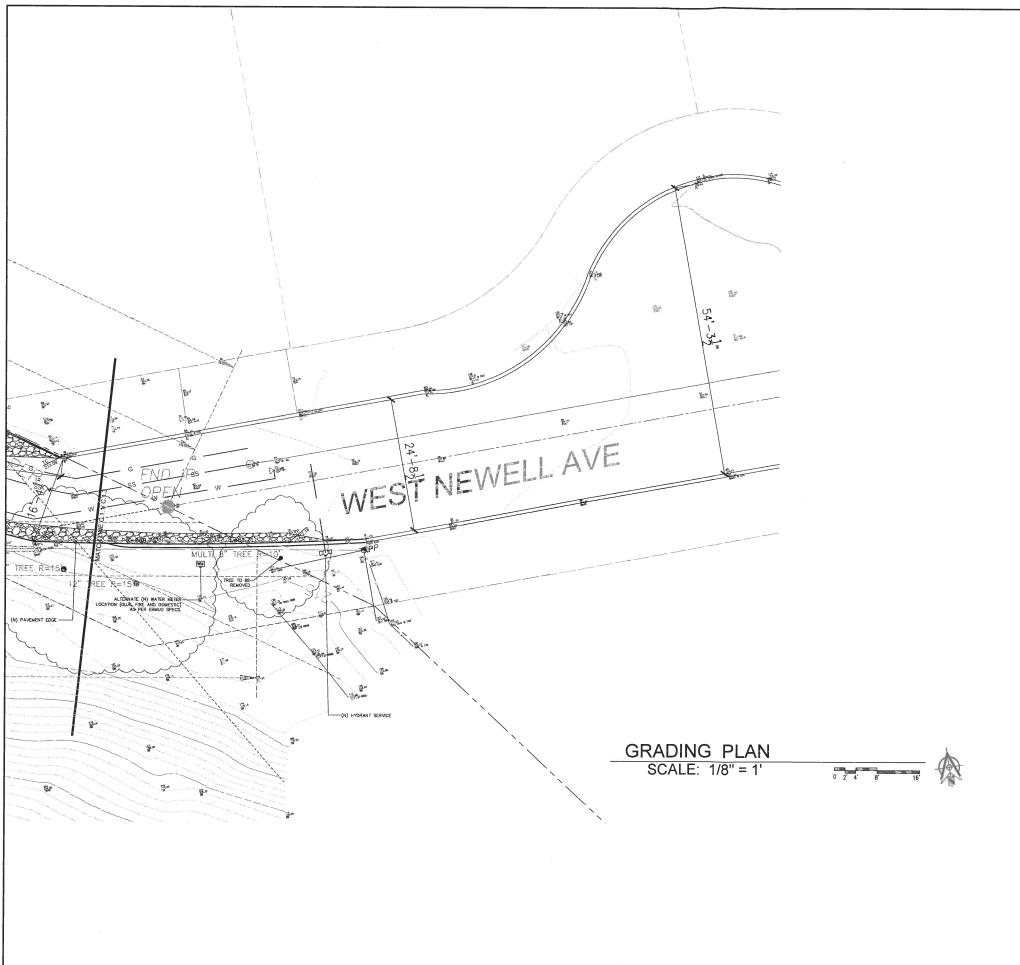SYMBOL DESCRIPTION PROPERTY LINE INDICATOR PERFORATED DRAIN PIPE PUMP DISCHARGE LINE SOLID DRAIN PIPE DRAINAGE SWALE ATRIUM DRAIN (SEE SHT.2, DETAIL C) SQUARE DRAIN (SEE SHT.2, DETAIL C) APPROX DOWNSPOUT LOC. (SEE SHT.2, DETAIL B) PIPE END PT. / CONNECTION GRATED STORM DRAIN CLEANOUT (SEE SHT.2, DETAIL C) PROP. SURFACE FLOW ARROW BUBBLE EMMITER (SEE SHT.2, DETAIL C) GRAVEL ACCESS ROAD WATER LINE FIRE HYDRANT UNDERGROUND ELECTRIC SERVICE GAS SERVICE >-- SANITARY SEWER LATERAL -- SANITARY SEWER MAIN/LATERAL EXT.



DAVID MONTALBO & TAMBRI HEYDEN 448 BLUE RIDGE DRIVE MARTINEZ, CA 94553

0 W. NEWELL AVE. WALNUT CREEK, CA 94595 APN: 238-050-007

(925) 872-5192

PLANNING GRADING PLAN **NEWELL AVE.** 0 WEST

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PROJECT No.: DRAWN BY: CHECKED BY: DATE: 10/8/19

CONTRACTOR AGREES THAT HE/SHE SHALL ASSUME SOLE AND COMPLETE RESPONSIBILITY FOR 10B SITE CONDITIONS DURING THE COURSE OF CONSTRUCTION OF THIS PROJECT, INCLUDING SAFETY OF ALL PERSONS AND PROPERTY; THAT THIS REQUIREMENT SHALL APPLY CONTINOUSLY AND NOT BE LIMITED TO NORMAL, WORKING HOURS, AND THAT THE CONTRACTOR SHALL DEFEND, INDEMNIFY AND HOLD THE OWNER AND THE ENGINEER HARMLESS FROM ANY AND ALL LIABILITY, REAL OR ALLEGED, IN CONNECTION WITH THE PERFORMANCE OF WORK ON THIS PROJECT, EXCEPTING FOR LIABILITY ARISING FROM SOLE NEGLIGENCE OF THE OWNER OR ENGINEER.

GRADING NOTES:


NOTE: THIS DRAWING IS APPROVED SUBJECT TO:


- 1. APPROVAL OF THIS PLAN APPLIES ONLY TO (A) THE EXCAVATION, PLACEMENT, AND COMPACTION OF NATURAL EARTH MATERIALS, (B) THE INSTALLATION OF ON-SITE (I.E. PRIVATE PROPERTY) STORM WATER CONVEYANCE AND TREATMENT FACILITIES THAT ARE OUTSIDE OF THE S-FOOT BUILDING ENVELOPE, AND (C) THE INSTALLATION OF RETAINING STRUCTURES. THIS APPROVAL DOES NOT CONFER ANY RIGHTS OF ENTRY TO EITHER PUBLIC PROPERTY OR THE PRIVATE PROPERTY OF OTHERS. APPROVAL OF THIS PLAN ALSO DOES NOT CONSTITUTE APPROVAL OF ANY IMPROVEMENTS WITH THE EXCEPTION OF THOSE LISTED ABOVE, ARE SUBJECT TO REVIEW AND APPROVAL BY THE RESPONSIBLE AUTHORITIES AND ALL OTHER REQUIRED PERMITS SHALL BE OBTAINED.
- 2. UNLESS OTHERWISE NOTED ON THE PLAN, ANY DEPICTION OF A RETAINING STRUCTURE ON THIS PLAN SHALL NOT CONSTITUTE APPROVAL FOR CONSTRUCTION OF THE RETAINING STRUCTURE UNLESS A SEPARATE STRUCTURE ALL REVIEW, BY THE DEPARTMENT OF PUBLIC WORKS IS COMPLETED
- 3. THIS PLAN DOES NOT APPROVE THE REMOVAL OF TREES. APPROPRIATE TREE REMOVAL PERMITS AND METHODS OF TREE PRESERVATION SHOULD BE OBTAINED FROM THE CITY'S PLANNING DEPARTMENT AND THE CITY ARBORIST.
- 4. PERIMETER BUILDING GRADES SHALL SLOPE AWAY FROM BUILDINGS AT LEAST 5% MINIMUM.
- 5. ALL DOWNSPOUTS SHALL RELEASE TO STORMWATER CONTROLS THEN TO THE STORM COLLECTOR PIPE SYSTEM .
- 6. PROPOSED PERMANENT AND TEMPORARY SLOPES AND COMPACTION AND TRENCHING REQUIREMENTS ARE TO BE APPROVED BY THE PROJECT GEOTECHNICAL ENGINEER AND AS PER THE RECOMMENDATIONS OF THE PROJECT GEOTECHNICAL REPORT.
- 7. GRADING WITHIN THE PG&E SETBACK/DOMAIN TO BE APPROVED BY PG&E.

PROJECT EARTH QUANTITIES:

CUT: 510 C.Y.

FILL: 260 C.Y.

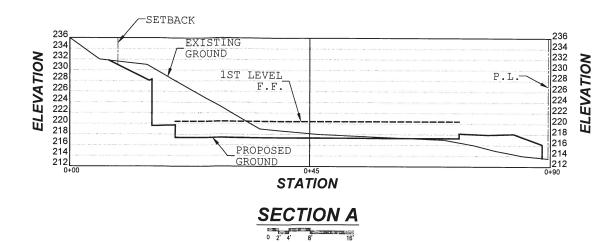

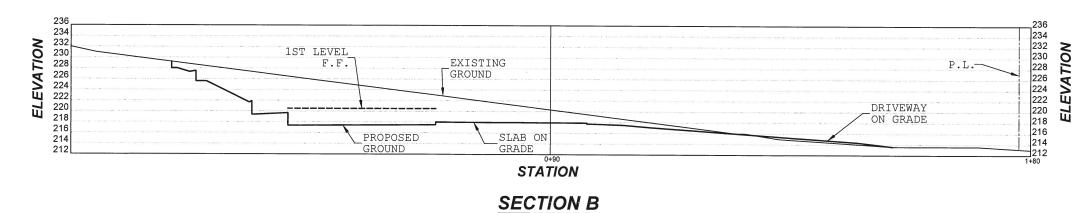



448 BLUE RIDGE DRIVE DAVID MONTALBO 8 TAMBRI HEYDEN

(925) 872-5192

CA 94595 0 W. NEWELL AVE.

APN: 238-050-007

AVE. **WEST NEWELL**


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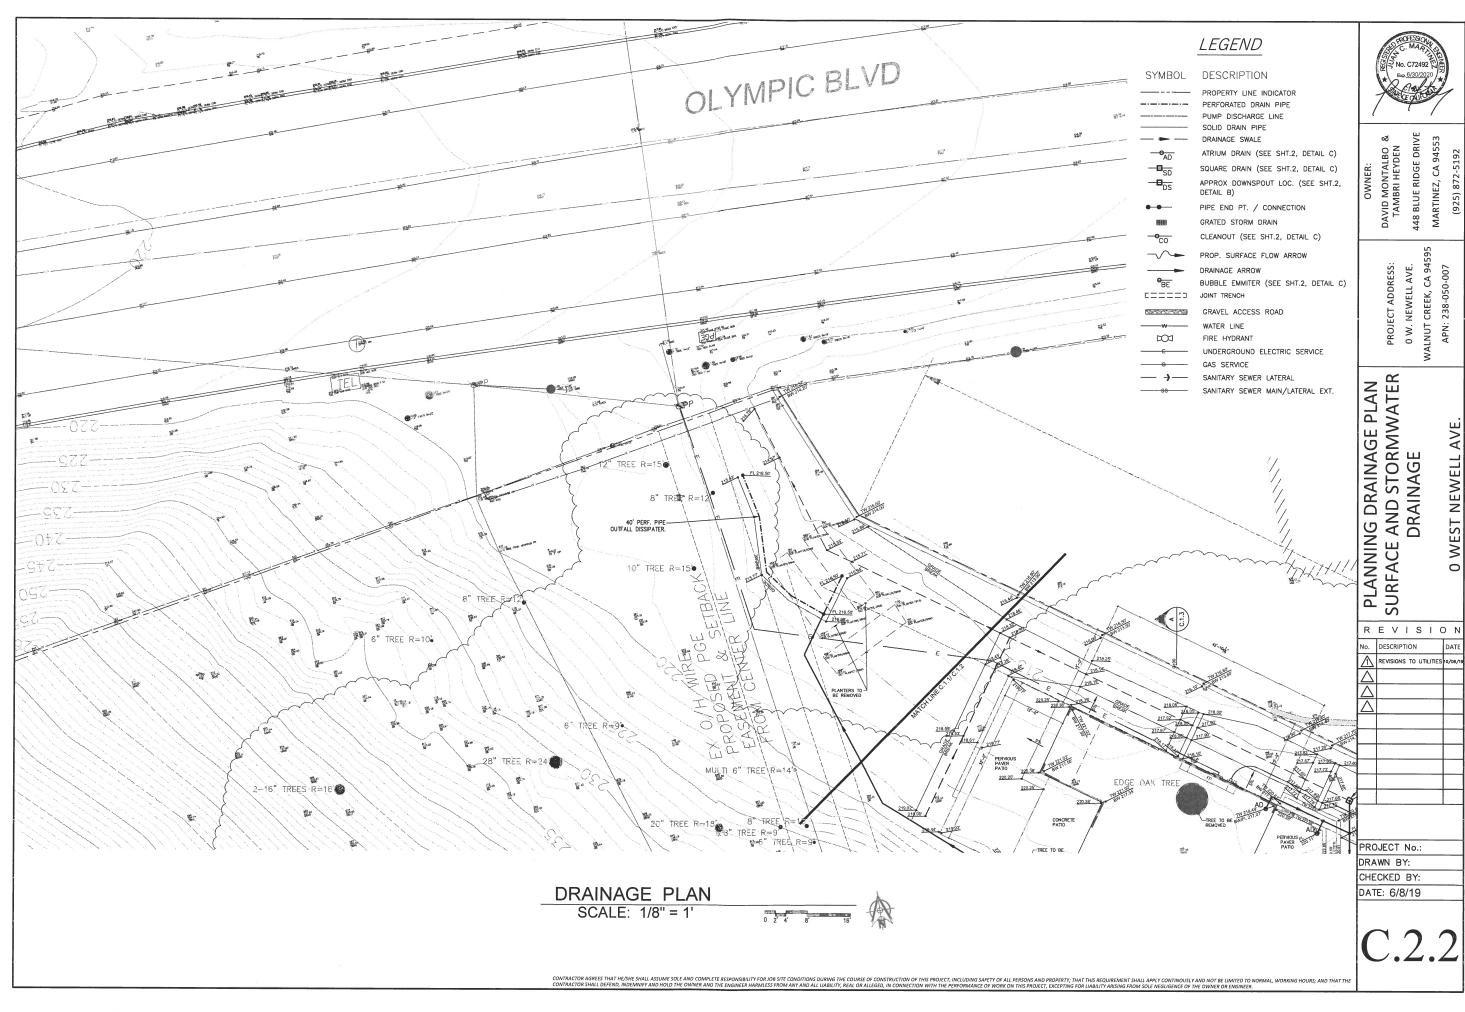
PLANNING GRADING PLAN SECTIONS AND NOTES


REVISION No. DESCRIPTION

PROJECT No.: DRAWN BY: CHECKED BY: DATE: 6/8/19


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PROJECT ADDRESS:

448 BLUE RIDGE DRIVE MARTINEZ, CA 94553

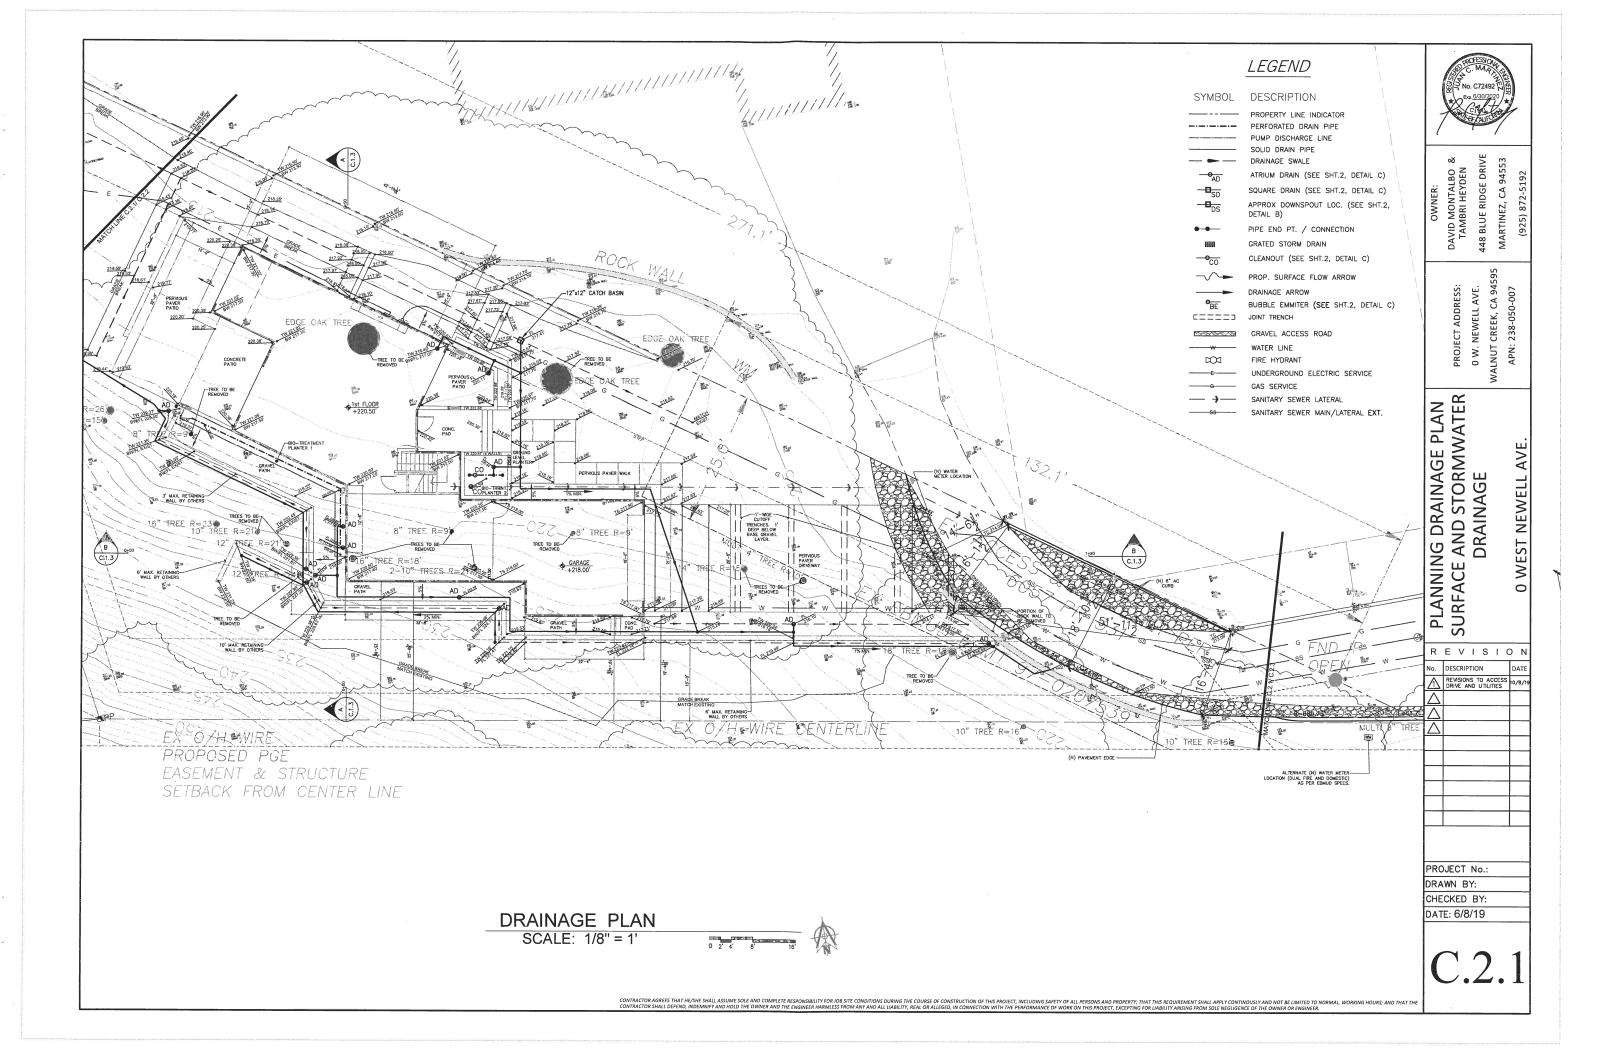(925) 872-5192

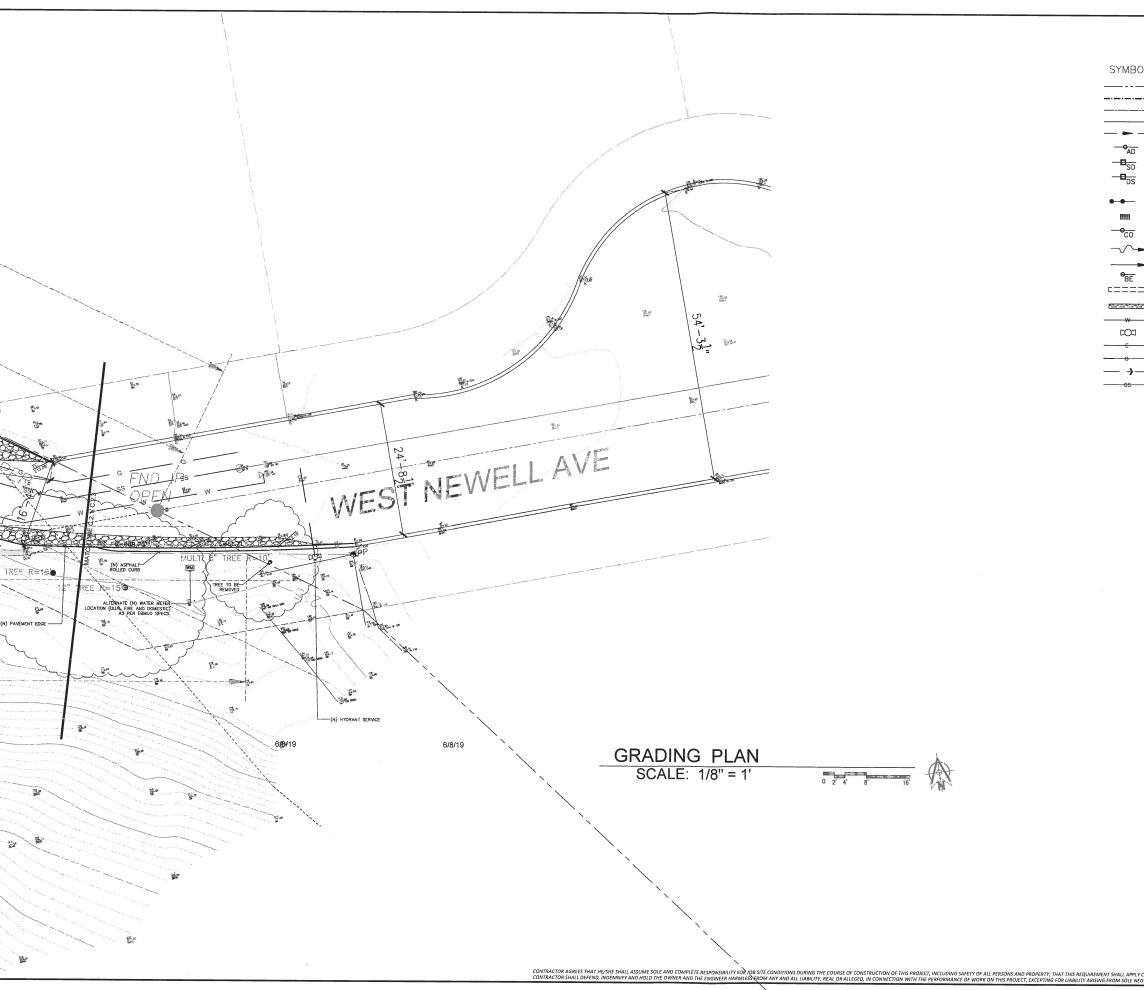
0 W. NEWELL AVE. WALNUT CREEK, CA 94595 APN: 238-050-007

PLANNING DRAINAGE PLAN SURFACE AND STORMWATER DRAINAGE 0 WEST NEWELL AVE
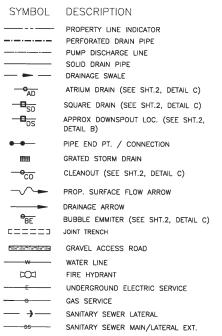
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DRAWN BY: CHECKED BY: DATE: 10/8/19




DRAINAGE PLAN NOTES:

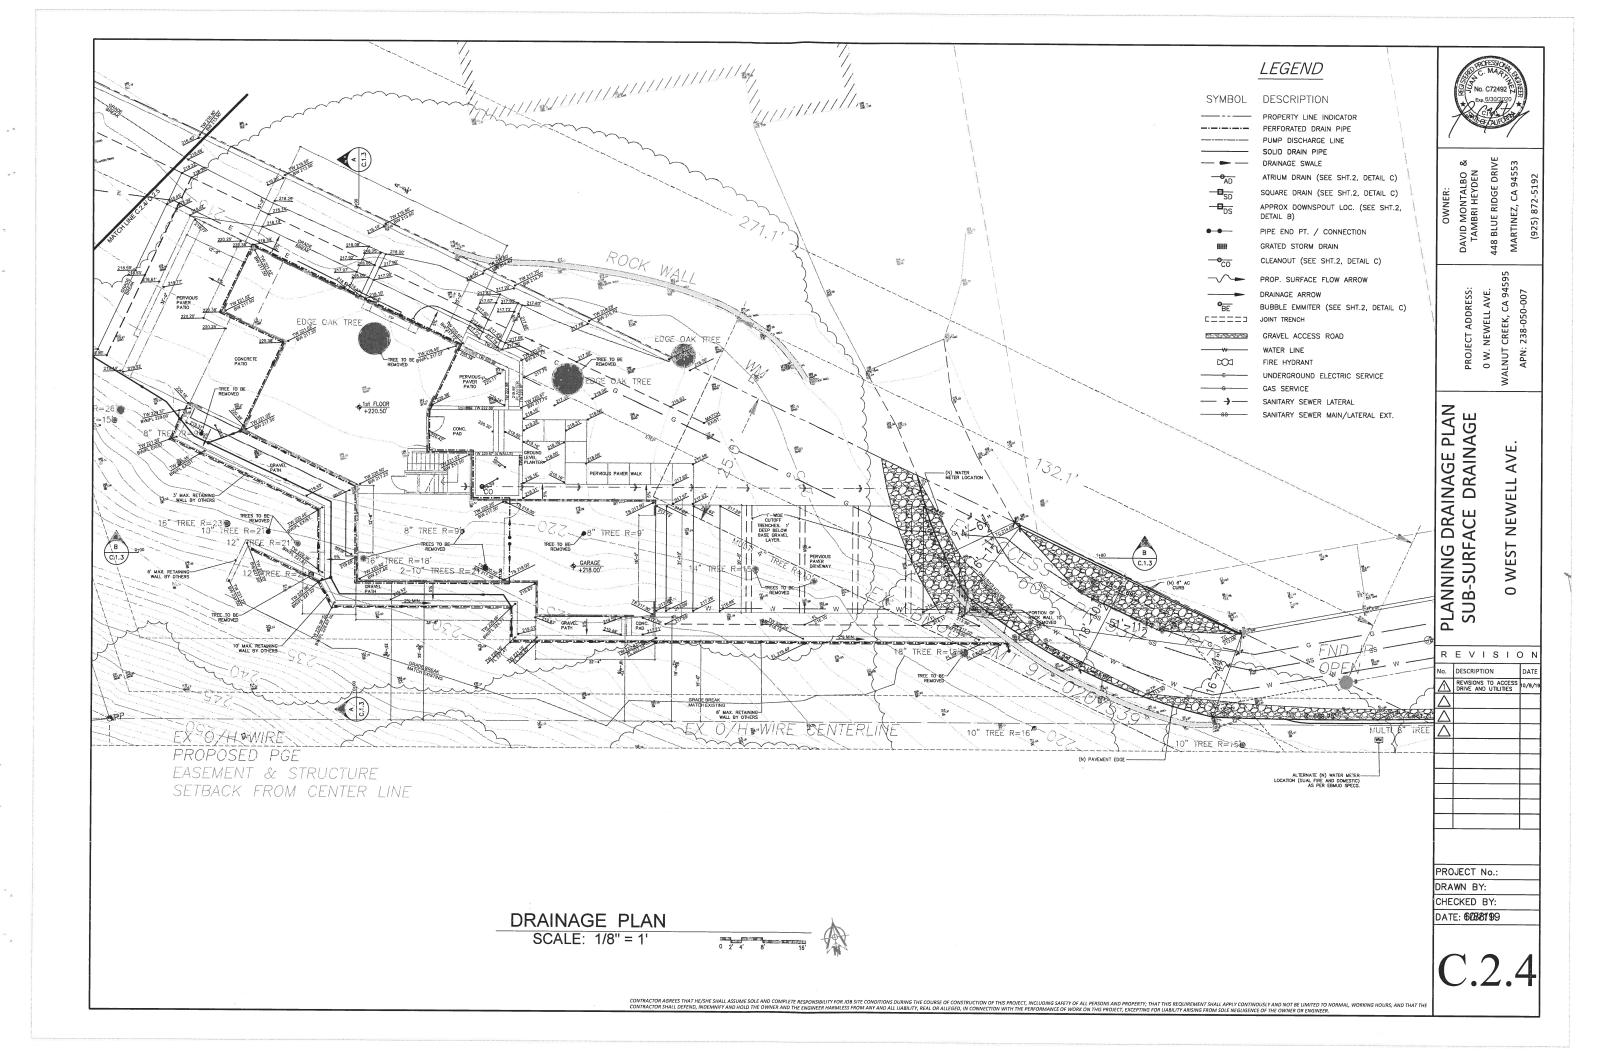
- DRAINAGE DESIGN. DRAINAGE SYSTEM DESIGNED TO CONVEY UP TO THE 10- YR STORM EVENT.
- 2. <u>GUTTERS AND DOWNSPOUTS.</u> GUTTERS AND DOWNSPOUTS SHALL BE AS PER THE ARCHITECTURAL REQS. AND SPECS. SEE ARCHITECTURAL PLAN.
- 3. GUTTER DESIGN SPECIAL CONSIDERATIONS. GUTTER DESIGN SHALL ENSURE 10-YR FLOW RATE FROM ROOF IS DELIVERED TO STORMWATER/DRAINAGE SYSTEM. GUTTER SEPARATORS SHALL ENSURE THAT DESIGNATED AREAS OF ROOF DRAIN TO THE DESIGNATED STORMWATER TREATMENT CONTROLS.
- 4. <u>RETAINMENTS.</u> RETAINMENTS AS SHOWN ON THIS PLAN ARE DESIGNED AS PER THE STRUCTURAL PLAN OR DESIGNED BY OTHERS. REFER TO THE STRUCTURAL PLAN AND THE GEOTECHNICAL ENGINEER'S SOILS REPORT.
- 5. PIPE TRENCHING. TRENCHING SHALL BE AS RECOMMENDED IN THE THE GEOTECHNICAL ENGINEER'S SOILS REPORT AND/OR ACCORDING TO TRECHING STANDARDS.
- 5. <u>SUB-SURFACE DRAIANGE.</u> THE SUB-SURFACE DRAINAGE SYSTEM DESIGNED ON THIS PLAN AND RELEASE SHALL BE AS APPROVED BY THE PROJECT GEOTECHNICAL ENGINEER.

STORMWATER NOTES:

- 1. SITE AREA= 111,517 S.F. (2.56 ACRE)
- 2. TOTAL NEW IMPERVIOUS COVER AREA (ROOFS, PORCHES, AND PATIOS)=
 4112 SF. TOTAL REPLACED IMPERVIOUS COVER AREA = 0 SF. PROJECT
 SITE IS SINGLE FAMILIY RESIDENTIAL AND BETWEEN 2,500 SF AND 10,000
 SF. OF NEW/REPLACED IMPERVIOUS COVER AREA.
- 3. DRIVEWAY, PATIOS, AND WALKS/PATHS FROM STREET ARE DESIGNATED TO BE PERVIOUS PAVERS OR GRAVE!
- 4. ELEVATIONS AND DRAINAGE PATTERNS OUTLINED IN THIS PLAN SHALL BE ADHERED TO TO INSURE THAT IMPERVIOUS AREAS DRAIN AWAY FROM BUILDINGS AND TO VEGETATED AREAS AND/OR STORWATER CONTROLS.

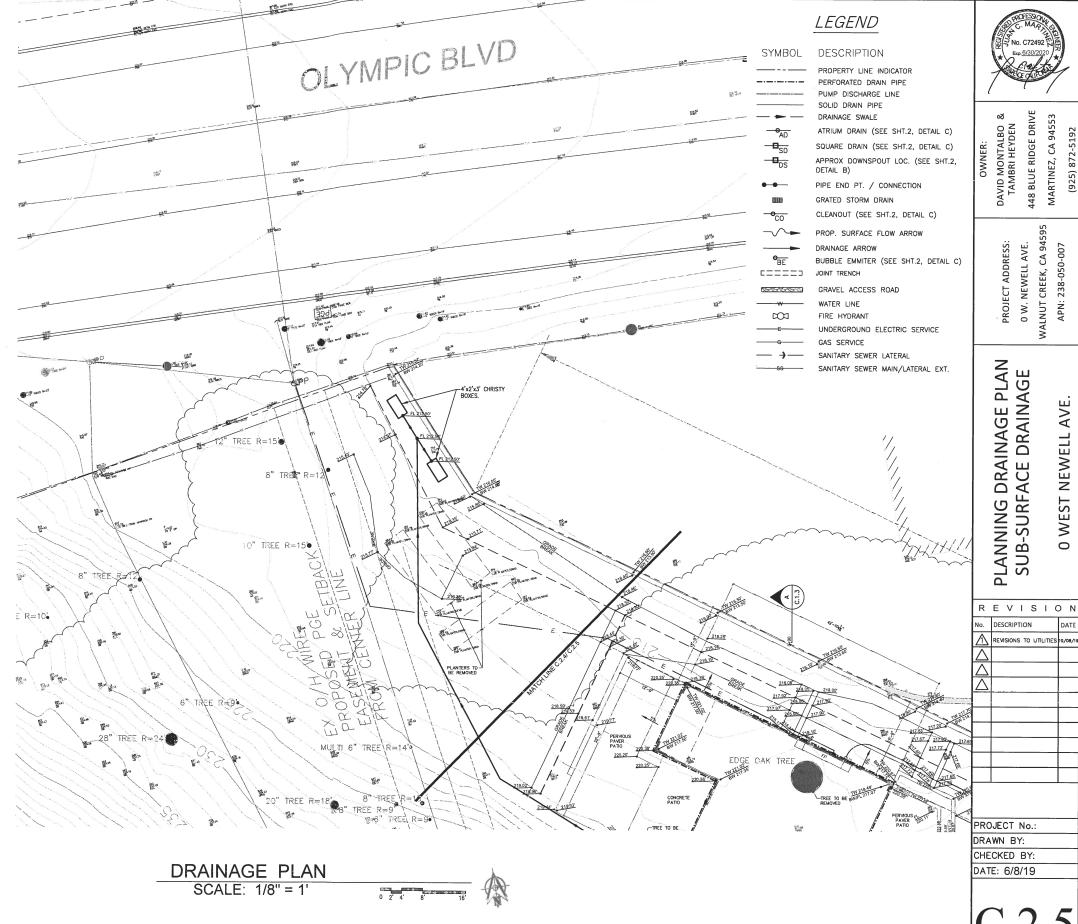

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STORMWATER CALCS

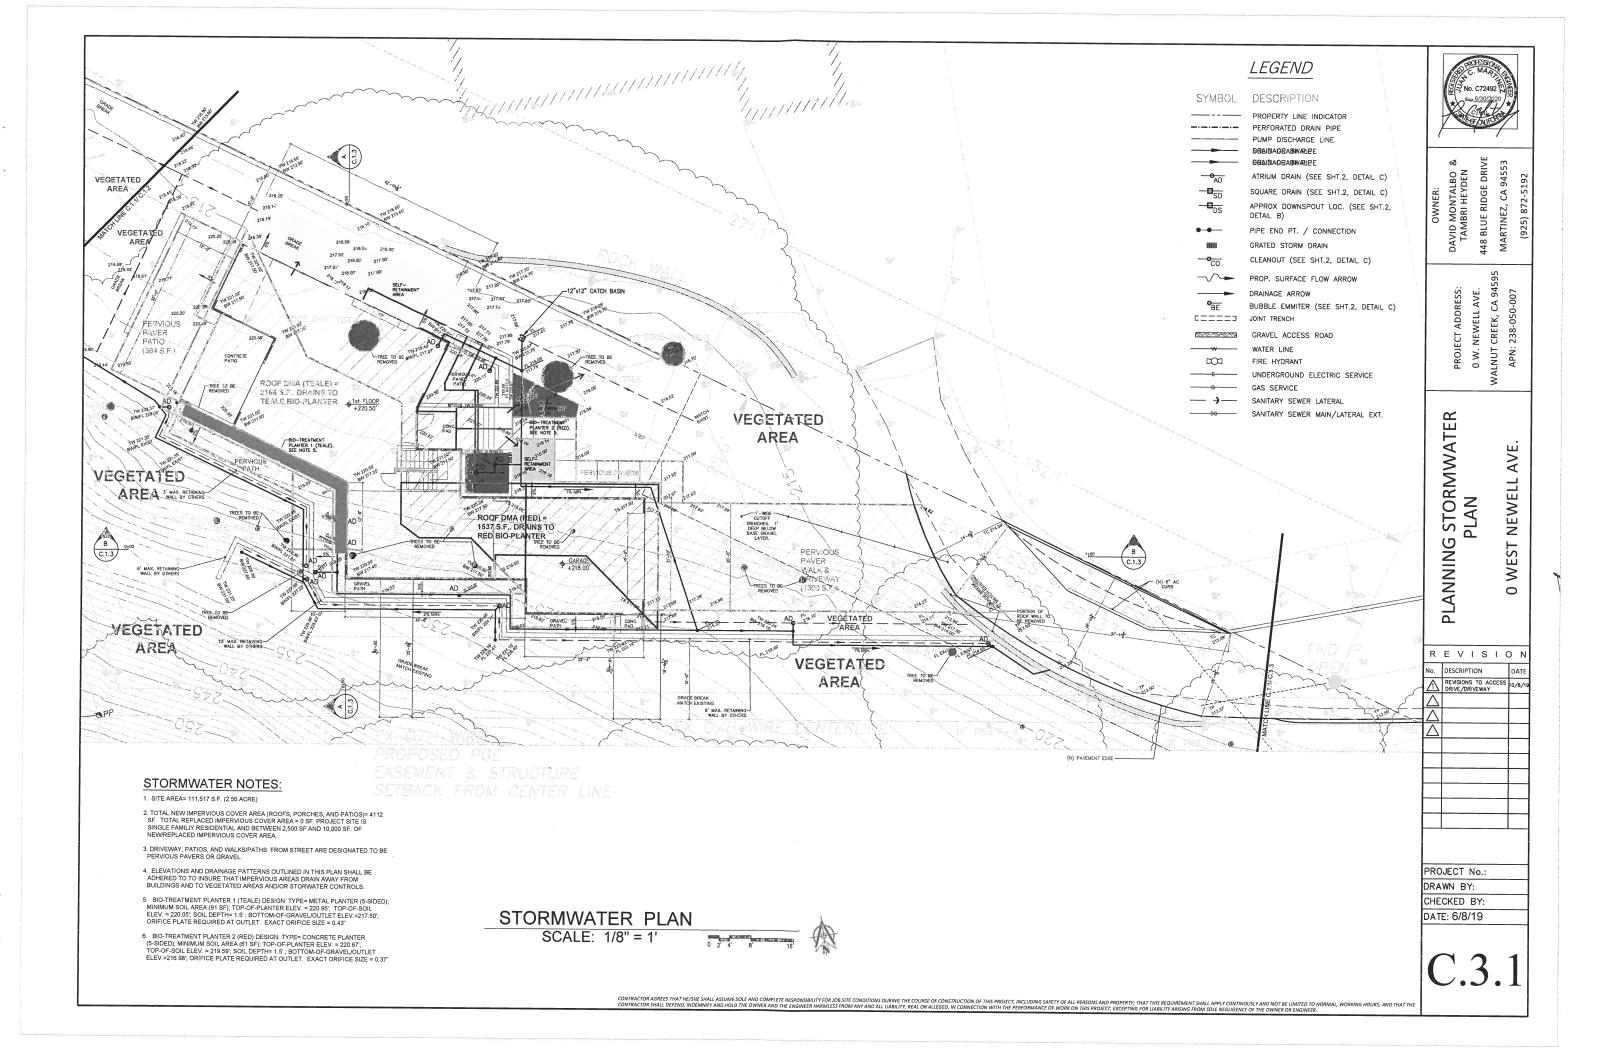NOTES

ROOF AREA DMA. SF 1537 1ST/2ND FLR ROOFS

ROOF AREA DMA, SF SOIL AREA, SF V1 DEPTH, FT SOIL DEPTH, FT V2/GRAVEL DEPTH, FT Q_{10-VR}, CFS

1.11
1.11
1.13
0=C*I*A; PARAMETERS FROM C.C. CO
1.49 Q = Cw*L*d**, d=(Q/(Cw*L))**, Cw =2.3
3.65
0.37
219.59
220.44

d, IN (FOR 6" PIPE)
TOTAL DEPTH
ORIFICE SIZE, IN
TOP-OF-SOIL ELEV., FT
RISER FL ELEV., FT OUTLET FL ELEV., FT 216.98 TOP-OF-PLANTER ELEV., FT 220.67

SOUTH-SIDE PLANTER (TEALE)
ROOF AREA DMA, SF
SOIL AREA, SF
V1 DEPTH, FT
SOIL DEPTH, FT
SOIL DEPTH, FT
Q_{16,100}, CFS
(16,100, CFS) 2166 1ST/2ND FLR ROOFS AND 2ND FLOOR PATIOS

0.222019972 Q=C*i*A; PARAMETERS FROM C.C. CO 1.177219561 Q = Cw*L*d*, d=(Q/(Cw*L))**, Cw =2.3 0.43

d, IN (FOR 2, 6" PIPES)
ORIFICE SIZE, IN
TOP-OF-SOIL ELEV., FT 220.05 220.85 220.95 217.50 RISER FLELEV. FT TOP-OF-PLANTER ELEV., FT OUTLET FL ELEV., FT

NORTH-SIDE SELF-RETAINING AREA (YELLOW)
ROOF AREA DMA, SF 317 1ST/2ND FLR ROOFS
1* RUNOFF VOLUME 26.41666667
SELF-RETAINING AREA, SF 439
SELF-RETAINING VOLUME, CF 27.65

ENTRY SELF-RETAINING AREA (CYAN) 50 ENTRY AND STEPS

ENTRY DMA, SF 50
1" RUNOFF VOLUME 4.166666667
SELF-RETAINING AREA, SF 62
SELF-RETAINING VOLUME, CF 5.166666667

ENTRY SELF-RETAINING AREA (MAGENTA) 42 ENTRY AND STEPS

ENTRY OMA, SF 42 E
1" RUNOFF VOLUME 3.5
SELF-RETAINING AREA, SF 50.25
SELF-RETAINING VOLUME, CF 4.731875


Page 1

IMPERVIOUS COVER

TOTAL IMPERVIOUS, SF SITE AREA, SF SITE AREA, ACR

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NORTH-SIDE SELF-RETAINING AREA (YELLOW)

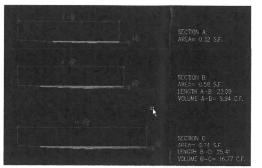

Page 2

Project Name: 0 W. NEWELL Project Type: Treatment and Flow Control APN: 238-050-007 Drainage Arsa: 14,200 Mean Annual Precipitation: 24.8 IV. Areas Draining to IMPs IMP Name: ENTRY FLO.THRU PLANTER (RED)
IMP Type: Flow-Through Planter
Soil Group: ENTRY FLO.THRU PLANTER (RED)
DMA Name Area (st it) Post Project DMA Runoff DMA Area x
Surface Type Factor Runoff Factor
ENTRY ROOPS 1,537 Conventional 1.00 1,537 Rain M Adjustment Factor IMP Sizing Factor Minimum Area or Volume Proposed Area or Volume 1,537 Surface Volume Subsurface Volume Flow (cfs) Orifice The product of the SIP String Factor and the RainItil Adjument Factor was less than the minimum value of 0.04. The value of 0.04 was used to adjust the area Rain Adjustment Factor 0.900 Minimum Area or Volume Proposed Area or Volume 2,166 Surface Volum

The product of the IMP Stoing Factor and the Rainfall Adjument Factor was less Gan the minimum value of 0.04. The value of 0.04 was used to a sjust the area instead.

Report generated on 6/9/2019 12:00:00 AM by the Contra Costa Clean Water Program IMP Sizing Tool software (version 1.3.1.0).

Underdrain Flow (cfs)

0.43

(925) 872-5192

DAVID MONTALBO & TAMBRI HEYDEN 448 BLUE RIDGE DRIVE MARTINEZ, CA 94553

CA 94595 0 W. NEWELL AVE. ALNUT CREEK, CA 945 PROJECT ADDRESS: APN: 238-050-007

PLANNING STORMWATER
PLAN

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PROJECT No.: DRAWN BY: CHECKED BY: DATE: 6/8/19

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