SF STONE VALLEY 005



(NEAR) SMITH ROAD & OAK ROAD ALAMO, CA 94507

PSL #433513 ORDER #31329439

SITE INFORMATION

PSL #:

OWNER: 245 MARKET STREET

SAN FRANCISCO, CA 94110 CONTACT: MARK ANDERSON

TEL (925) 459-8052 APPLICANT:

VERIZON WIRELESS

2785 MITCHELL DRIVE, SUITE 9 WALNUT CREEK, CA 94598

AGENT: EPIC WIRELESS

222 W. LOCKEFORD STREET SUITE 9 LODI, CA 95240

(IFO) 196-100-005 APN ADJACENCY:

SITE ADDRESS: (NEAR) SMITH ROAD & OAK ROAD

COUNTY: CONTRA COSTA

ZONING:

ZONING JURISDICTION: CITY OF CONTRA COSTA COUNTY DEPARTMENT OF PUBLIC WORKS

VICINITY MAP Team Gauguin

CODE COMPLIANCE

CONSTRUCTION WORKS AND MATERIALS MUST COMPLY WITH ALL APPLICABLE NATIONAL, STATE, AND LOCAL CODES AS ADOPTED BY LOCAL JURISDICTION, INCLUDING BUT NOT LIMITED TO:

- CALIFORNIA CODE OF REGULATIONS
- CALIFORNIA CODE OF REGULATIONS
 2016 CALIFORNIA BUILDING CODE
 2016 CALIFORNIA PULDINING CODE
 2016 CALIFORNIA PLUMBING CODE
 2016 CALIFORNIA PLUMBING CODE
 2016 CALIFORNIA BLECTRIC CODE
 2016 GEEN CODE
 2016 EDITION OF TITLE 24 ENERGY STANDARDS

- ANY LOCAL BUILDING CODE AMENDMENTS TO THE ABOVE
- CITY / COUNTY ORDINANCES
- 2016 CALIFORNIA FIRE CODES WITH ALL LOCAL AMENDMENTS
 GO 95

DRIVING DIRECTIONS

DIRECTIONS FROM VERIZON WIRELESS RF MARKET OFFICE:

- . HEAD NORTH-EAST ON MITCHELL DR TOWARDS OAK GROVE RD 2. TURN RIGHT ONTO OAK GROVE RD
- 3. TURN RIGHT ONTO YGNACIO VALLEY RD
 4. YGNACIO VALLEY RD TURNS RIGHT AND BECOMES HILLSIDE AVE
- 5. USE THE LEFT 2 LANES TO TURN LEFT ONTO THE INTERSTATE 680 S SLIP ROAD TO SAN
- 7. TAKE EXIT 42A FOR STONE VALLEY RD E TURN RIGHT ONTO STONE VALLEY RD
- 9 TURN RIGHT ONTO SMITH RD

PROJECT TEAM

AGENT

222 W. Lockeford Stree Lodi, CA 95240 Tel: (916) 781-5921

CONSTRUCTION MANAGER: ROB HERNANDEZ

LEASING & ZONING MGR: MARK LOBAUGH

ARCHITECT/ENGINEER

Meridian Management LLC 785 Oak Grove Road E2 Concord, CA 94518

PROJECT MANAGER: RODNEY BARNES

cell: 707.592.5924

CLIENT

Verizon Wireless 2785 Mitchell Drive Walnut Creek CA 94598

HANDICAP REQUIREMENTS

FACILITY IS UNMANNED AND NOT FOR HUMAN HABITATION. HANDICAPPED ACCESS NOT REQUIRED IN ACCORDANCE WITH CALIFORNIA ADMINISTRATIVE STATE CODE PART 2, TITLE 24. CHAPTER 11B, SECTION 1103B.



PROJECT DESCRIPTION

THIS IS AN UNMANNED THE ECOMMUNICATIONS FACILITY FOR THE VERIZON WIRELESS NETWORK CONSISTING OF THE INSTALLATION AND OPERATION OF AN ANTENNA AND ASSOCIATED FQUIPMENT ON AN EXISTING WOOD POLE IN THE PUBLIC RIGHT-OF-WAY.

SCOPE OF WORK

- INSTALL NEW TELECOMMUNICATIONS EQUIPMENT BOXES ON AN EXISTING 37.9' HT. PG&E WOOD POLE.
- POLE-MOUNTED EQUIPMENT TO BE INSTALLED ON A GO95 COMPLIANT STANDOFF BRACKET.
- EQUIPMENT CONSISTS OF (1) 4' HT. CANTENNA ON POLETOP, (2) RRUS, (2) POWER SUPPLY UNITS, (2) DIPLEXERS, (1) DISCONNECT SWITCH, (1) FIBER DEMARC BOX, (1) EQUIPMENT SHROUD, AND (1) POLE-MOUNTED POWER METER.
- ALL POLE EQUIPMENT TO BE PAINTED VALSPAR 'DEEP EARTH' COLOR. POWER SERVICE FROM OVERHEAD POC

DRAWING INDEX			
SHEET NO:	SHEET TITLE		
T.1	TITLE SHEET		
C.1	SITE SURVEY		
C.2	SITE SURVEY		
A.1	OVERALL SITE PLAN		
A.2	POLE PLAN ENLARGEMENTS		
A.3	ELEVATIONS		
A.4	ELEVATIONS		
A.5	EQUIPMENT DETAILS		
A.6	EQUIPMENT DETAILS		
A.7	EQUIPMENT DETAILS		
E.1	SINGLE LINE DIAGRAM, BUSS DIAGRAM, PANEL SCHEDULE		
E.2	POLE GROUNDING, ELECTRICAL DETAILS		
TC.1	SITE SPECIFIC VEHICLE TRAFFIC CONTROL PLAN		

ADMINISTRATIVE REQUIREMENTS

CONTRACTOR SHALL VERIFY ALL PLANS & (E) DIMENSIONS & CONDITIONS ON THE JOB SITE & SHALL IMMEDIATELY NOTIFY THE ENGINEER IN WRITING OF ANY DISCREPANCIES BEFORE PROCEEDING WITH THE WORK OR BE RESPONSIBLE FOR SAME IF USING 11"X17" PLOT, DRAWINGS WILL BE HALF SCALE

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2785 Mitchell Drive, Suite 9 Walnut Creek, CA 94598



Project Architect:



222 W. LOCKEFORD STREET SUITE 9 LODI, CA 95240

100% Construction Drawings

SF STONE VALLEY 005 (NEAR) SMITH ROAD & OAK ROAD ALAMO, CA 94507

PSL #433513

Site Name:

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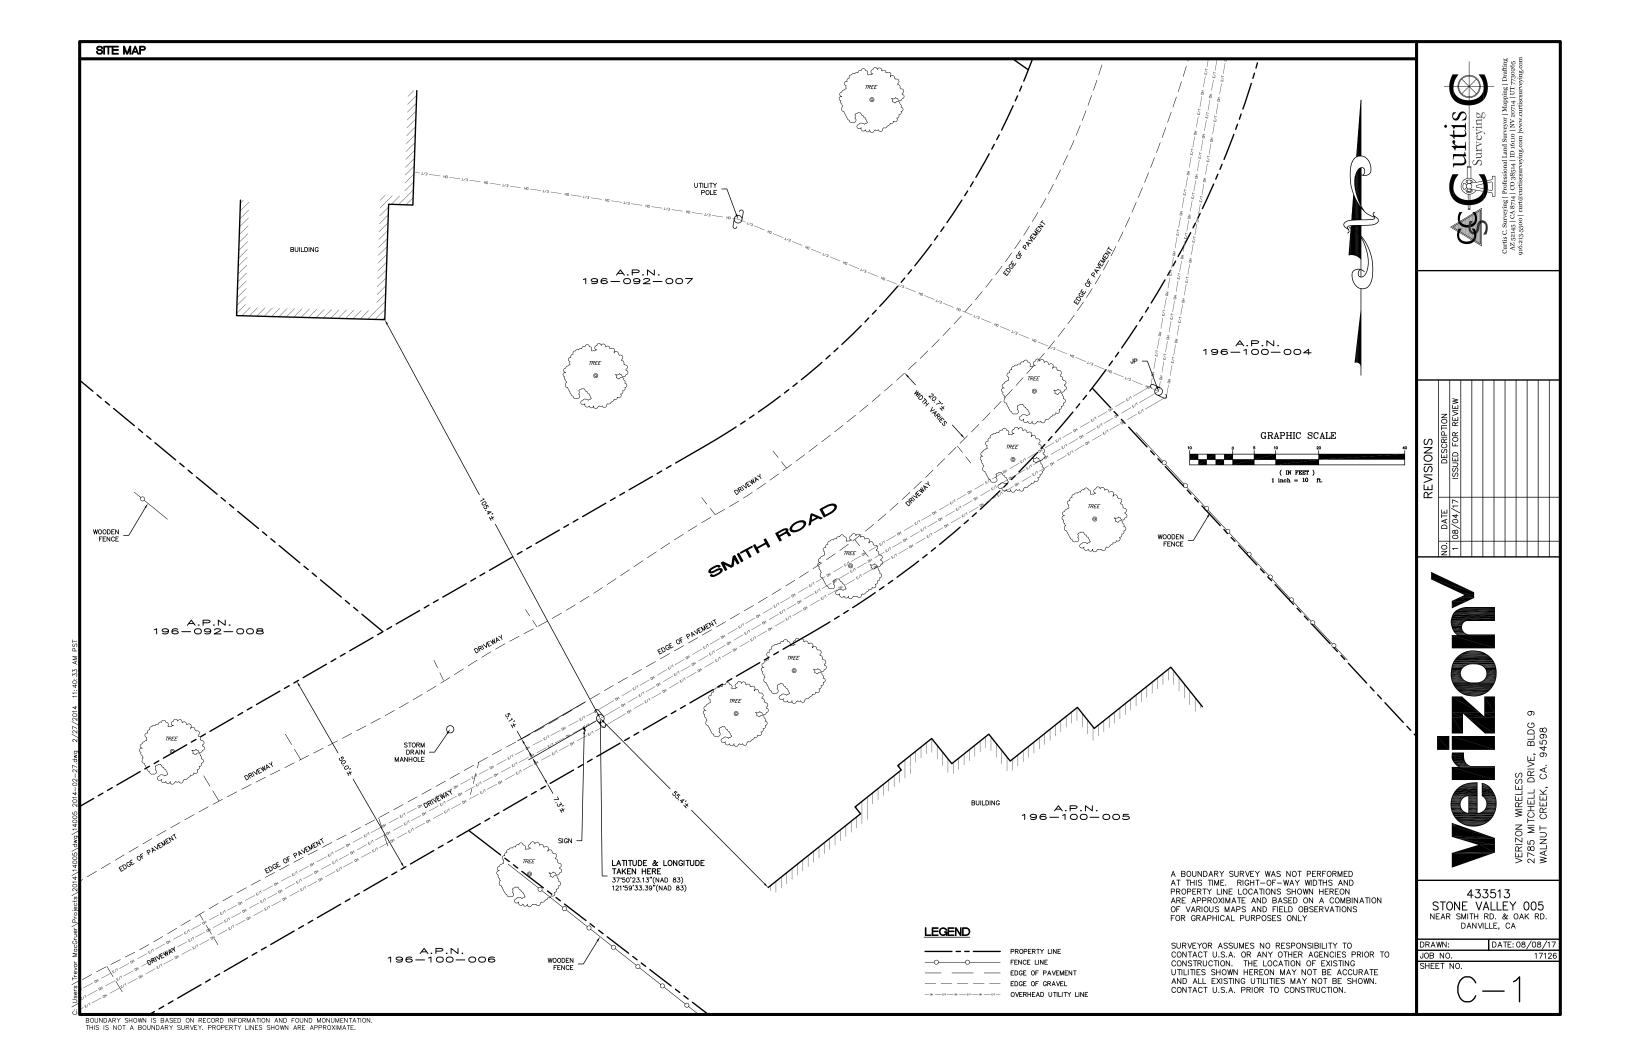
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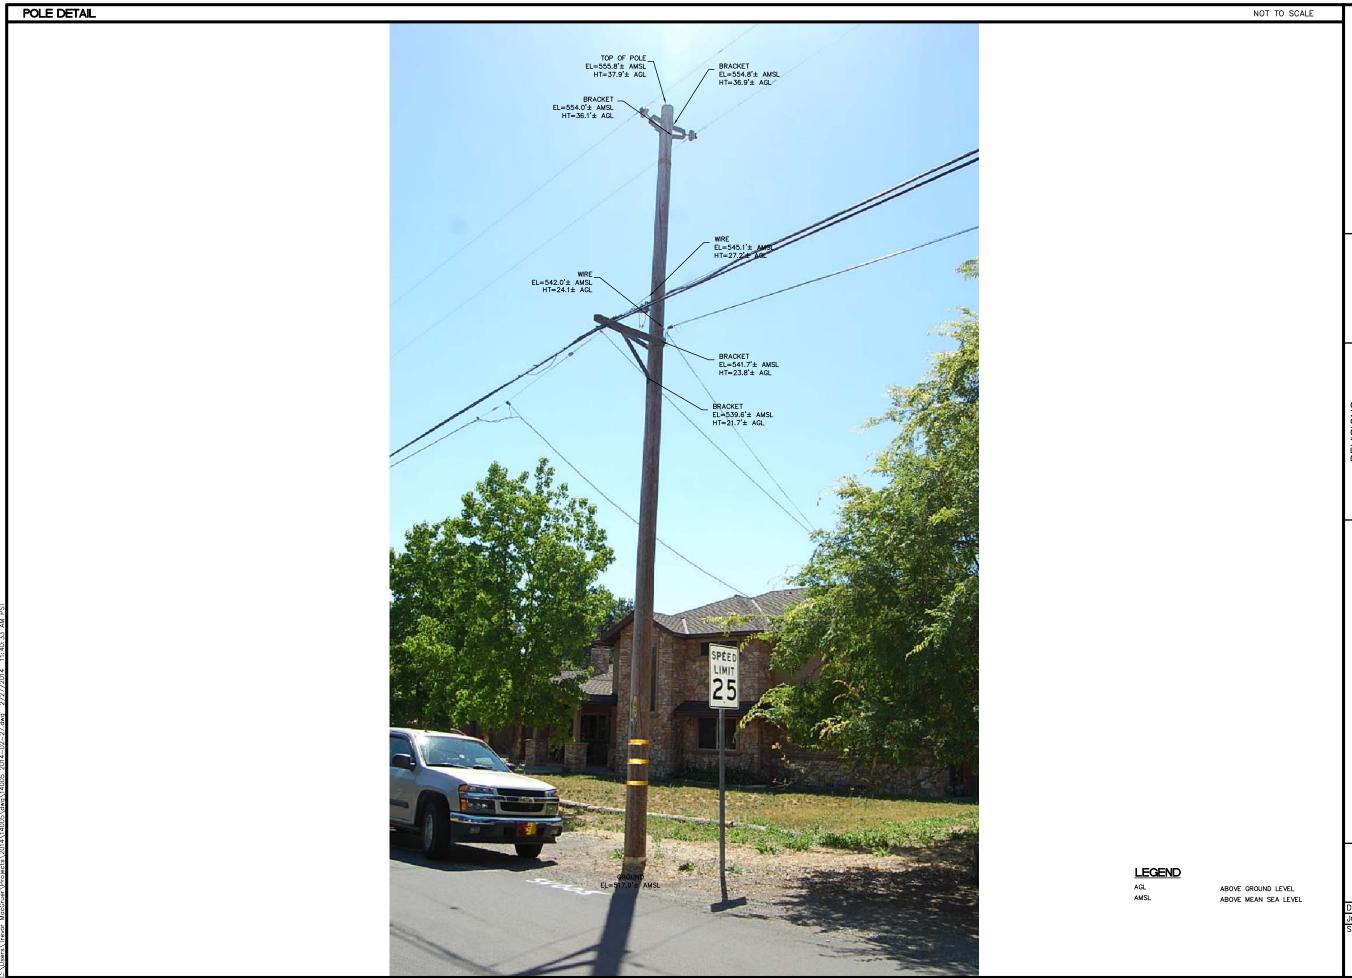
Project No.

Date: 08/16/18 Job No.: Scale: AS SHOWN CAD File:

Designed By: JG Checked:

TITLE SHEET





Curtis C. Surveying | Professional Land Surveyor | Mapping | Drafting ALE 2544 | COA 35544 | In Coa 35544 | In

REVISIONS

NO. DATE DESCRIPTION

1 08/04/17 ISSUED FOR REVIEW


VERIZON WIRELESS

433513 STONE VALLEY 005 NEAR SMITH RD. & OAK RD. DANVILLE, CA

DRAWN: DATE: 08/08/17

JOB NO. 17126

SHEET NO.

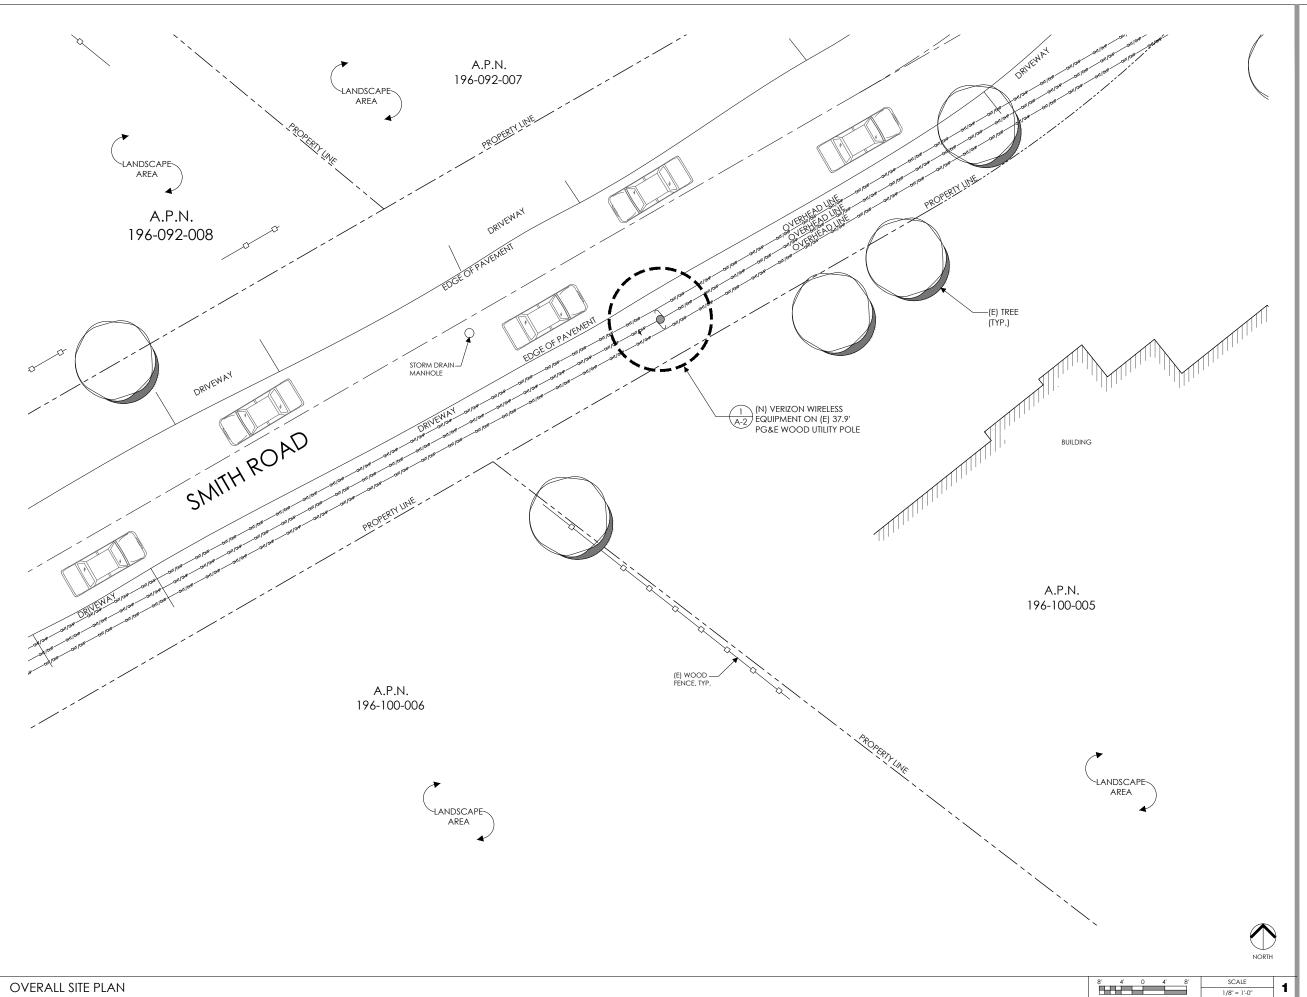



Clier



Project Architect:



222 W. LOCKEFORD STREET SUITE 9 LODI, CA 95240

Site Agent:

100% Construction
Drawings

Drawing Phase:

SF STONE VALLEY 005

(NEAR) SMITH ROAD & OAK ROAD ALAMO, CA 94507

PSL #433513

Site Name:

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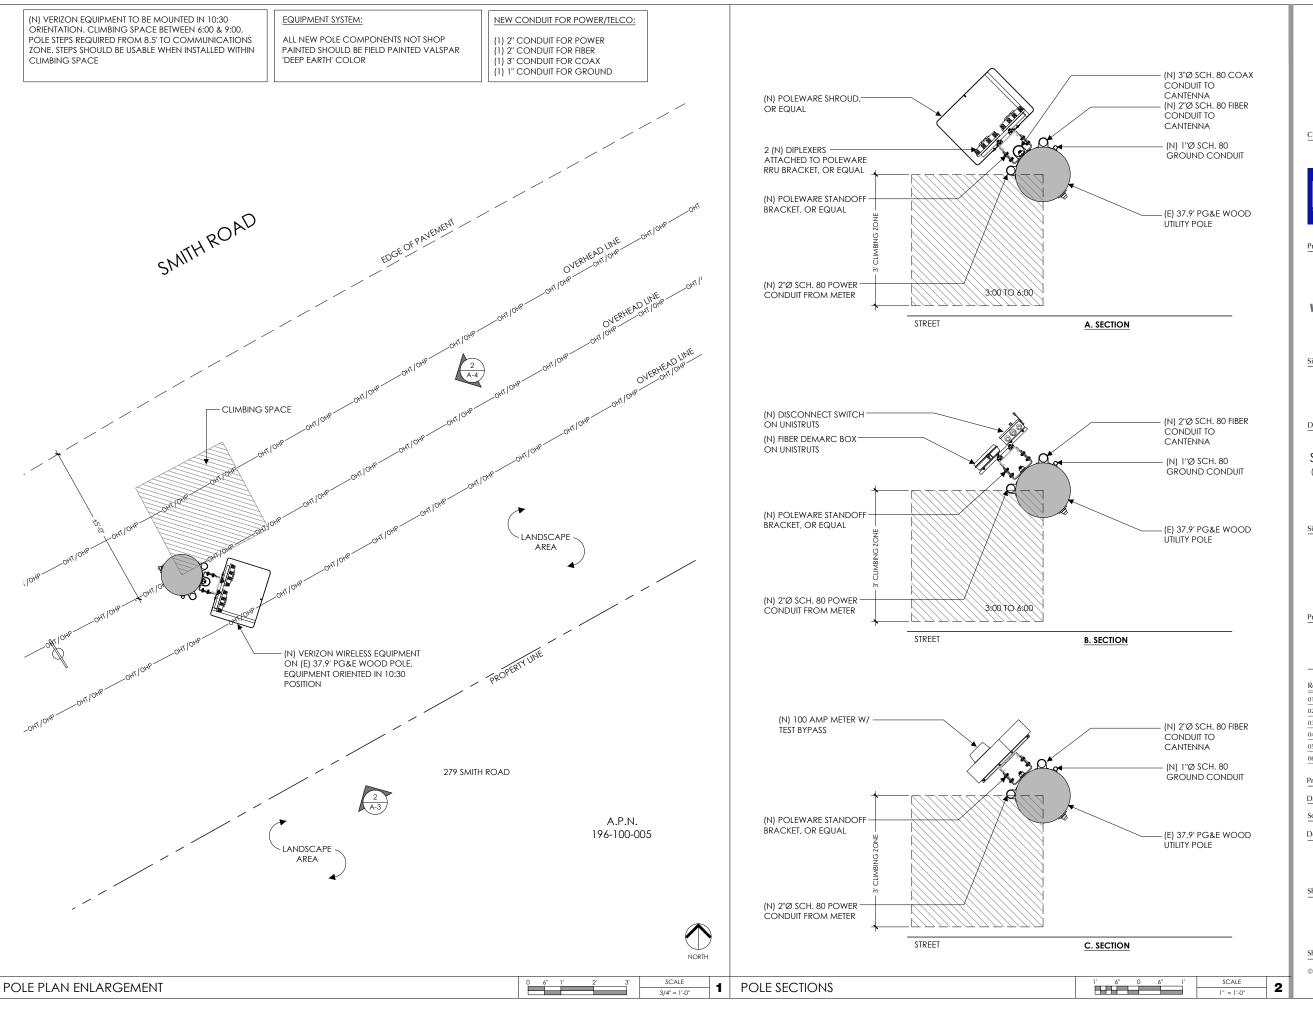
OVERALL SITE PLAN

Sheet Title:

A. ¹

Sheet No.:

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Project Architect:



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Site Agent:

100% Construction Drawings

(E) LIGHT POLE

Drawing Phase:

SF STONE VALLEY 005

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NEW CHARLES SMALL CELL CABINET

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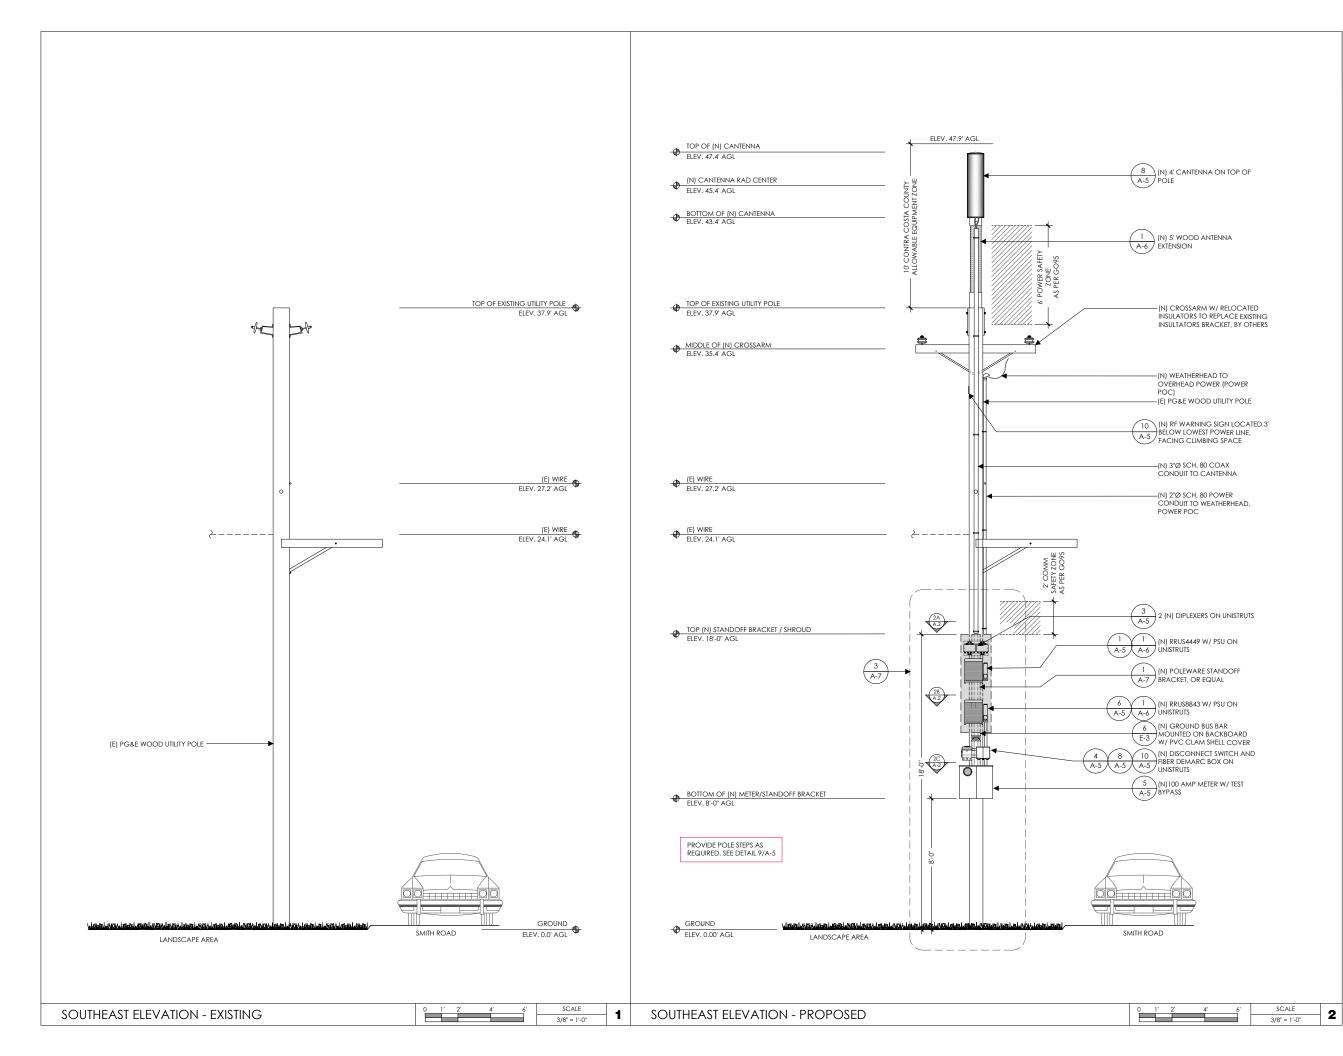
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POLE PLAN ENLARGEMENTS







Clien



Project Architect:



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Site Agent:

100% Construction Drawings

Drawing Phase:

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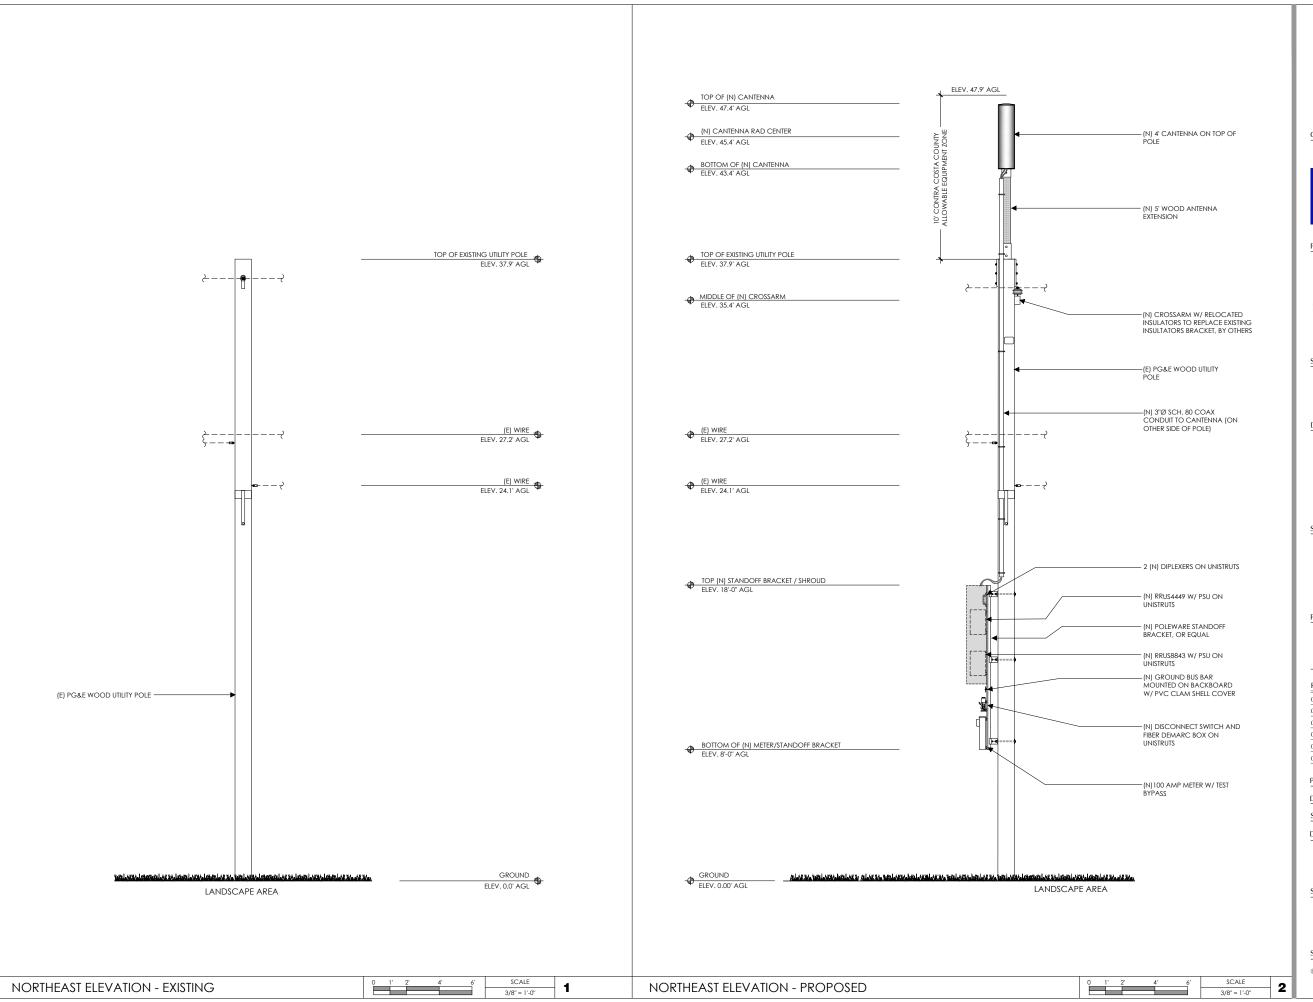
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ELEVATIONS

Sheet Title:

A.3

Sheet No.:





Clien



785 Oak Grove Road E2
Suite 251
Concord, CA 94518
T 707.592.5924
www.meridian.management

Project Architect:

WIRELESS GROUP LLC
Connecting o Wireless World

222 W. LOCKEFORD STREET SUITE 9 LODI, CA 95240

Site Agent:

100% Construction Drawings

Drawing Phase:

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Project No.:

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Designed By: JG Checked: RB

ELEVATIONS

Sheet Title:

A.4

Sheet No.:

UNIT: ERICSSON RRUS4449 B5 B13 W/

PROTRUDING ITEMS

HEIGHT: 18 INCHES

WIDTH: 13.2 INCHES

LENGTH: 9.4 INCHES

WEIGHT: 70 LBS (EXCLUDES MOUNTING HARDWARE)



UNIT: ERICSSON RRUS8843 W/ PROTRUDING ITEMS

HEIGHT: 18 INCHES

WIDTH: 13.2 INCHES

DEPTH: 11.3 INCHES

WEIGHT: 75 LBS

RRUS8843


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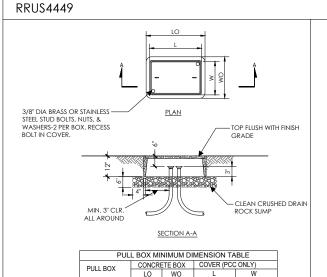


MODEL # DESCRIPTION: POLE $\frac{5}{8}$ X 10 INCH GALVANIZED 99 LBS AERIAL SERVICE COMPANY, INC. 1-800-256-5186

POLE STEPS ARE USED ON WOOD POLES WHERE FREQUENT ACCESS TO POLE MOUNTED EQUIPMENT IS REQUIRED. HAIT DRIVING SURFACE AND SHAPP POINT EASE INSTALLATION. FETTER-DRIVE THERAD PERMITS REMOVAL WITH A WRENCH. HOT-DIPPED GALVANIZED FOR CORROSION RESISTANCE. NOTCHED MARK ON STEP INDICATES PROPER



WOOD POLE 6 | POLE STEPS 9

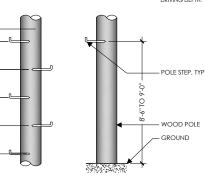

30" 17" 25-3/8" 13-1/4"

UNIT: FIBER DEMARC **ENCLOSURE BOX**

HEIGHT: 8.54 INCHES

WIDTH: 10 INCHES

DEPTH: 2.88 INCHES




HEIGHT: 48.0 INCHES

DIAMFTER: 14.6 INCHES

WEIGHT: 38.1 LBS (WITHOUT MOUNTING BRACKET)



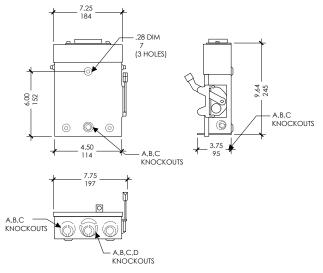

PULL BOX (IF REQUIRED)

FIBER DEMARC BOX

CANTENNA

DISCONNECT SWITCH

10 NOT TO SCALE

SCALE

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WIRELESS GROUP LLC

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100% Construction

Drawings

SF STONE VALLEY 005

(NEAR) SMITH ROAD & OAK ROAD ALAMO, CA 94507

PSL #433513

Project Architect:

Site Agent:

Drawing Phase:

Site Name:

785 Oak Grove Road E2

Concord CA 94518 707.592.5924

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EQUIPMENT

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2

100 AMP METER W/ TEST

BYPASS HEIGHT: 24 INCHES

12 INCHES

UNIT:

WIDTH:

DEPTH: 4-5/8 INCHES



NOTE: NEW PHENOLIC SIGN ATTACHED TO INSIDE PANEL NORMAL SHUT-DOWN PROTOCOLS: 1. Call 800-264-6620 NOC 24 HRS prior to schedule a shutdown day and time.

2. Give NOC the Node number 3. On scheduled day of shutdown, pull the disconnect handle to the "OFF" position.

4. Call NOC when work is completed. EMERGENCY SHUT-DOWN PROTOCOLS: 1. Call 800-264-6620 NOC immediately. 2. Give NOC the Node number _____.
3. Pull the disconnect handle to the "OFF" position.

LATCH-LOOP (LOCKABLE)

NEMA 3R RAIN COVER OUTSIDE PANEL DOOR SHOWING DISCONNECT SWITCH - DISC. OR PANEL DOOR W/

CONTRACTOR NOTE: SITE ID WILL BE SITE ID, MARKET ID,

SITE #, AND SITE NAME

 $\underline{\text{ON WOOD POLES}}$ - SIGN ON ALUMINUM WITH SS SCREW TO THE POLE 3' $\overline{\text{BELOW ANTENNA}}$ SIGN PLACEMENT:

AFFIX TO THE STRUCTURE 3-4' BELOW THE COMMERCIAL RF ANTENNA(S) OR
3' BELOW LOWEST POWER WIRE

SIGN COLOR: YELLOW

CONTRACTOR NOTE: SITE ID WILL BE SITE ID, MARKET ID, SITE #, AND SITE NAME

WEIGHT: 4.4 LBS

HEIGHT: 8.31 INCHES

WIDTH: 2.48 INCHES

DEPTH: 7.0 INCHES

DIPLEXER

3

METER

DISCONNECT SIGNAGE

4. Call NOC when work is completed.

RF WARNING SIGNAGE


Project No.:

Date: 08/16/18 Job No.:

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DETAILS

11

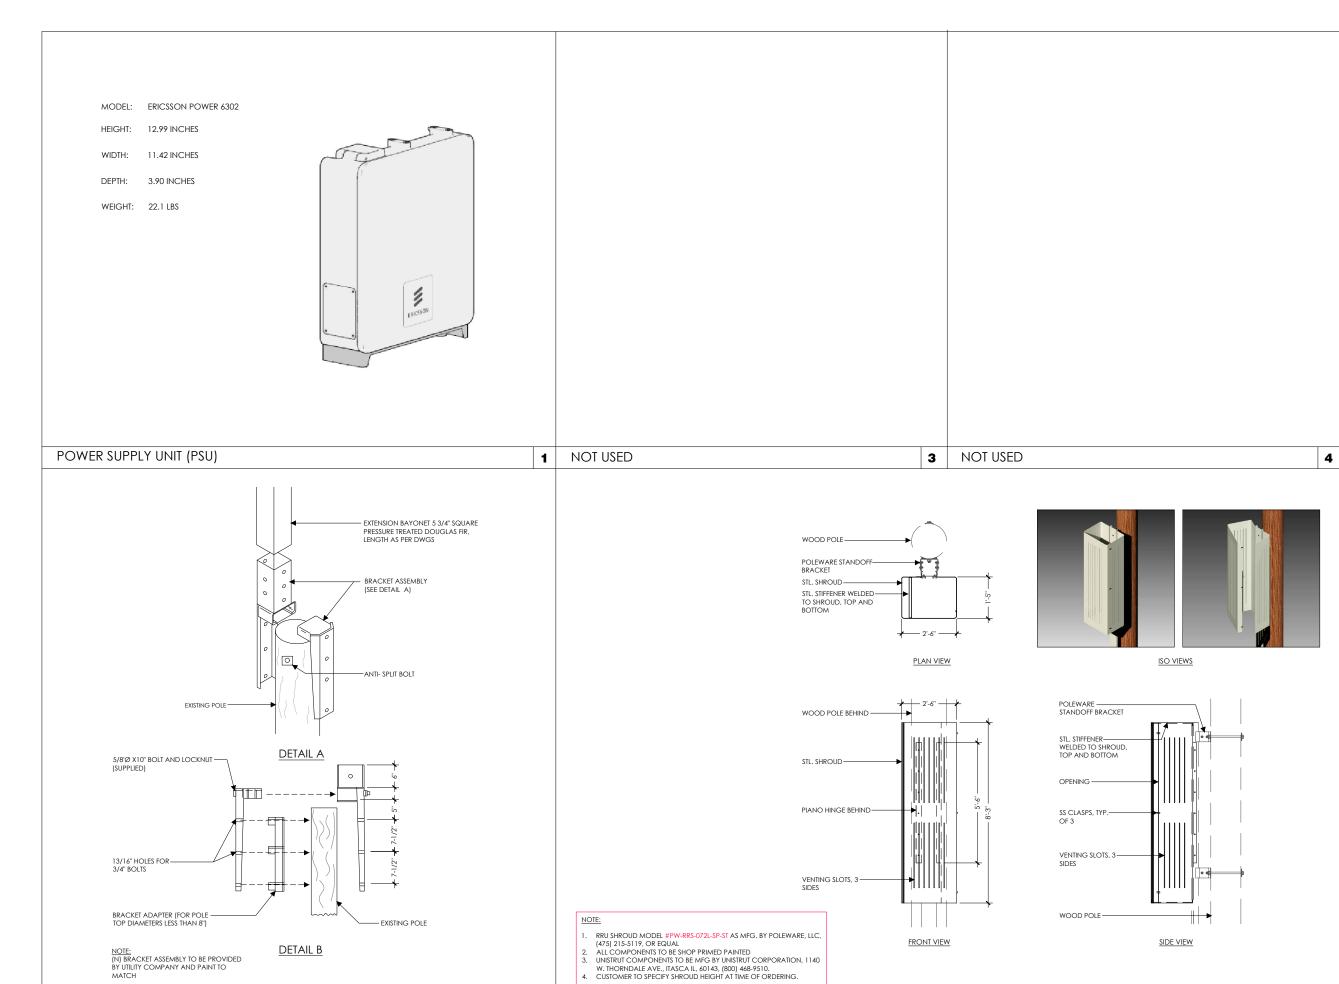

SCALE

NOT TO SCALE

2

EQUIPMENT SHROUD

POLETOP WOOD EXTENSION AND BRACKET



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Drawing Phase:

SF STONE VALLEY 005 (NEAR) SMITH ROAD & OAK ROAD

ALAMO, CA 94507 PSL #433513

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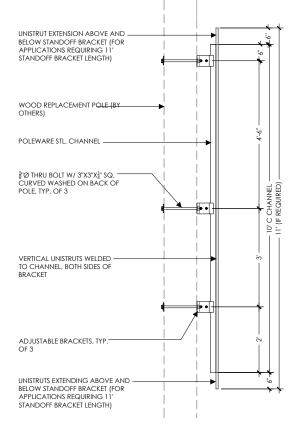
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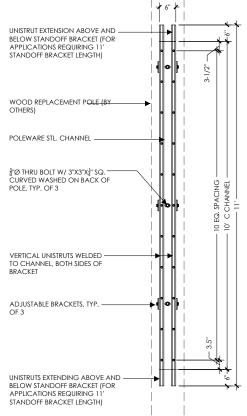
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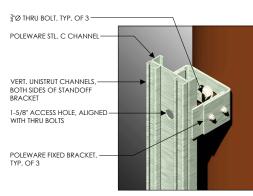
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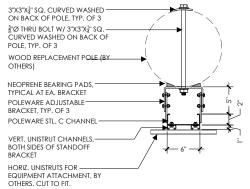
NOT TO SCALE 5







STANDOFF BRACKET BRACKET ISO




STANDOFF BRACKET FRONT ELEVATION

- STANDOFF BRACKET MODEL #PW-SOB-120L-SP-ST AS MFG. BY POLEWARE, LLC, (475) 215-5119, OR EQUAL
- LENGTH VARIES, CUSTOMER TO SPECIFY BRACKET LENGTH AT TIME OF ORDERING
 ALL COMPONENTS TO BE SHOP PRIMED PAINTED

STANDOFF BRACKET SIDE ELEVATION

- 4. UNISTRUT COMPONENTS TO BE MFG BY UNISTRUT CORPORATION, 1140
 W. THORNDALE AVE., ITASCA IL, 60143, (800) 468-9510.
 5. HORIZONTAL UNISTRUTS FOR EQUIPMENT INSTALLATION NOT INCLUDED
- NEOPRENE PADS AND ALL HARDWARE INCLUDED
 ALLOW 2-3 WEEKS FOR FABRICATION
 PATENT PENDING

NOT USED

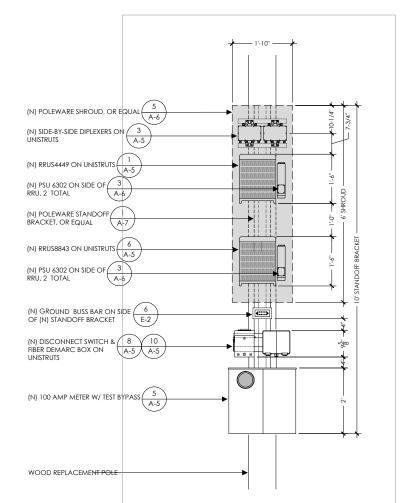

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Project Architect:



222 W. LOCKEFORD STREET SUITE 9 LODI, CA 95240

Site Agent:

100% Construction Drawings

Drawing Phase:

2

SF STONE VALLEY 005 (NEAR) SMITH ROAD & OAK ROAD

ALAMO, CA 94507

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EQUIPMENT DETAILS

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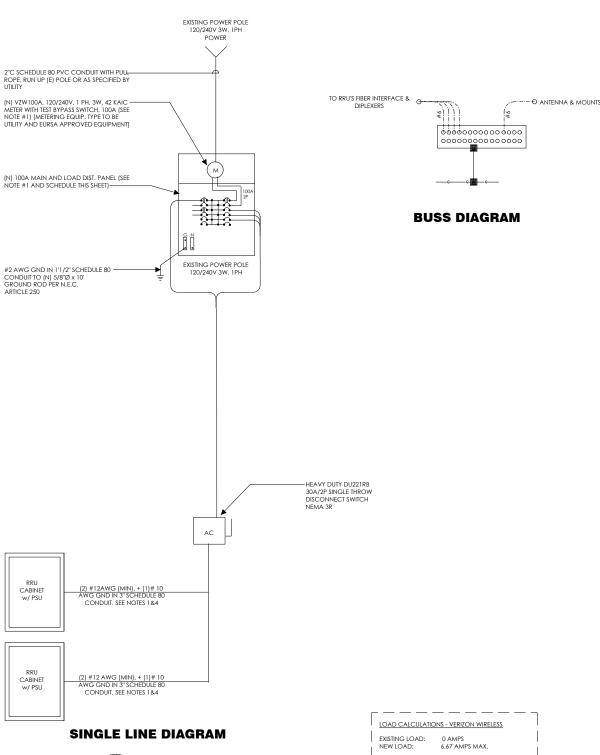
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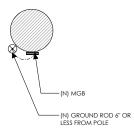
STANDOFF BRACKET PLAN

SCALE STANDOFF BRACKET NOT TO SCALE

POLE-MOUNTED EQUIPMENT CONFIGURATION

SCALE - 3 NOT TO SCALE





GROUNDING PLAN

EXISTING LOAD: 0 AMPS NEW LOAD: 6.67 AMPS MAX. NEW TOTAL LOAD: 6.67 AMPS MAX. NEW TOTAL LOAD: 6.67 AMPS MAX. POWER AND TELCO DESIGN IS BASED ON INITIAL SITE VISIT. CONTRACTOR SHALL OBTAIN CURRENT UTILITY COORDINATOR PLANS PRIOR TO START OF CONSTRUCTION. AVAILABLE FAULT CURRENT PER UTILITY. NOTE: CONTRACTOR TO CHECK WITH UTILITY TO ENSURE ELEC. METER IS BRACED FOR ACTUAL FAULT CURRENT.

POWER AND TELCO NOTES:


- POWER AND TELCO POINTS OF CONNECTION AND ANY EASEMENTS ARE PRELIMINARY AND SUBJECT TO CHANGE BY THE UTILITY COMPANIES.
- 2. CONTRACTOR SHALL COORDINATE WITH UTILITY COMPANY FOR FINAL AND EXACT WORK/MATERIALS REQUIREMENTS AND CONSTRUCT TO UTILITY ENGINEERING PLANS AND SPECIFICATIONS ONLY WHERE APPLICABLE PER PROJECT SCOPE OF WORK.
- 3. CONTRACTOR SHALL FURNISH AND INSTALL CONDUIT, PULL WIRES, CABLE PULL BOXES, CONCRETE ENCASEMENT OF CONDUIT, TRANSFORMER PAD, BARRIERS, POLE RISER TRENCHING, BACK FILL, AND UTILITY FEES, AND INCLUDE REQUIREMENTS IN SCOPE.
- CONTRACTOR SHALL LABEL ALL MAIN DISCONNECT SWITCHES
 AS REQUIRED BY CODE.

NOTES

- SUBCONTRACTOR SHALL PROVIDE DIST, PANEL AND BREAKERS FOR POWER TO THE PSU FOR EACH RRU.
- ALL SERVICE EQUIPMENT AND INSTALLATIONS SHALL COMPLY
 WITH THE N.E.C. AND UTILITY COMPANY AND LOCAL CODE
 REQUIREMENTS.
- SUBCONTRACTOR SHALL PROVIDE ELECTRICAL SERVICE ENTRANCE EQUIPMENT WITH FAULT CURRENT RATINGS GREATER THAN THE AVAILABLE FAULT CURRENT FROM THE POWER UTILITY.
- 4. MAXIMUM ONE WAY CIRCUIT RUN NOT TO EXCEED 75 FEET.

GENERAL ELECTRICAL NOTES:

- PROVIDE ALL ELECTRICAL WORK & MATERIALS AS SHOWN ON THE DWGS, AS CALLED FOR HEREIN, & AS IS NECESSARY TO FURNISH A
 COMPLETE INSTALLATION.
- THE INSTALLATION SHALL CONFORM TO THE REQUIREMENTS OF THE CURRENT ADOPTED CALIFORNIA ELECTRICAL CODE, STATE OF
 CALIFORNIA TITLE24, ALL OTHER APPLICABLE CODES AND ORDINANCES & THE REQUIREMENTS OF THE FIRE MARSHALL. ALL EQUIPMENT
 & WIRING SHALL BEAR THE APPROVAL STAMP OF UNDERWRITERS LABORATORY (UL) OR AN APPROVED TESTING LABORATORY,
 PAYMENT FOR ALL INSPECTION FEES AND PERMITS ARE PART OF THIS CONTRACT.
- 3. THE CONTRACTOR SHALL BE RESPONSIBLE FOR THE SAFETY AND GOOD CONDITION OF ALL MATERIALS & EQUIPMENT FOR THE ENTIRE INSTALLATION & UNIT COMPLETION OF WORK, ERECT & MAINTAIN APPROVED & SUITABLE BARRIERS, PROTECTIVE DEVICES & WARNING SIGNS, BE FULLY RESPONSIBLE FOR ANY LOSS OR INJURY TO PERSONS OR PROPERTY RESULTING FROM NEGLIGENCE AND/OR ENFORCEMENT OF ALL SAFETY PRECAUTIONS & WARNINGS.
- 4. COORDINATE THE ELECTRICAL INSTALLATION WITH ALL OTHER TRADES.
- 5. ALL SAW CUTTING, TRENCHING, BACK FILLING & PATCHING SHALL BE PART OF THIS CONTRACT.
- 6. FINALIZE ALL ELECTRICAL SERVICE ARRANGEMENTS, INCLUDING VERIFICATION OF LOCATIONS, DETAILS, COORDINATION OF THE INSTALLATION & PAYMENT OF ACCRUED CHARGES WITH LOCAL POWER COMPANY, VERIFY LOCATION FOR FACILITIES & DITAILS WITH POWER UTILITY, IN ADDITION TO THE REQUIREMENTS SHOWN IN THE CONTRACT DOCUMENTS, WORK SHALL COMPLY WITH CONSTRUCTION STANDARDS & SERVICE REQUIREMENTS OF THE RESPECTIVE UTILITIES, INCLUDING ANY SUPPLEMENTAL DWGS ISSUED & SHALL BE SUBJECT TO APPROVAL OF THESE UTILITIES.
- 7. ALL WIRING SHALL BE COPPER. INSULATION FOR BRANCH CIRCUIT CONDUCTORS SHALL BE TYPE "THWN" CONDUCTORS LARGER AND
 #4 AWG MAY RE TYPE "THWN" OR "TWN"
- 8. PROVIDE CONDUIT SEALS FOR ALL CONDUITS PENETRATING WEATHERPROOFING OR WEATHERPROOF ENCLOSURE ENVELOPE. MASTIC SEAL ALL CONDUIT OPENING PENETRATIONS COMPLETELY WATERTIGHT.
- 9. UNILESS SHOWN OTHERWISE, FUSED DISCONNECT SWITCHES SHALL BE PROVIDED WITH LOW-PEAK, SYDUAL ELEMENT FUSES SIZED TO EQUIPMENT NAMEPLATE FUSE CURRENT RATING. MOTOR STARTERS SHALL BE PROVIDED WITH SIMILARLY SIZED FUSIBLE ELEMENTS, SWITCHES AND OTHER OUTDOOR EQUIPMENT SHALL BE RATED NEMA 3R AND/OR UL LISTED FOR WET ENVIRONMENT.
- 10. THE CONTRACTOR SHALL BE RESPONSIBLE FOR TESTING THE GROUNDING SYSTEM AND ENSURING A 5 OHM OR LESS GROUNDING PATH, ADDITIONAL GROUND RODS AND/OR CHEMICAL ROD SYSTEM SHALL BE USED TO ACHIEVE THIS REQUIREMENT IF THE GIVEN DESIGN CANNOT BE MADE TO ACHIEVE THIS REQUIREMENT.

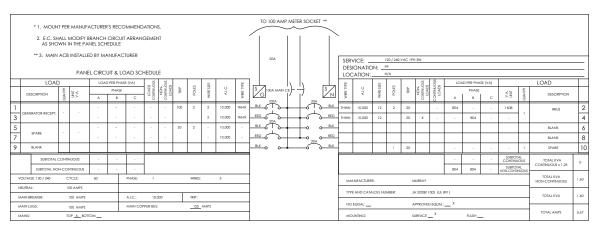

PANEL SCHEDULE -- PANEL " PP "

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Verizon Wireless 2785 Mitchell Drive, Suite 9 Walnut Creek, CA 94598

Clien



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Suite 251
Concord, CA 94518
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www.meridian.management

Project Architect:



222 W. LOCKEFORD STREET SUITE 9 LODI, CA 95240

Site Agent:

100% Construction
Drawings

Drawing Phase:

SF STONE VALLEY 005 (NEAR) SMITH ROAD & OAK ROAD ALAMO, CA 94507

PSL #433513

Site Name:

Professional Se

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Rev.	Date	Description
01	08/11/17	Constr. Dwgs 90%
02	08/24/17	Constr. Dwgs 90%
03	09/25/17	Constr. Dwgs 100%
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05	08/09/18	Constr. Dwgs 90%
06	08/16/18	Constr. Dwgs 100%

Project No.:

Date: 08/16/18 Job No.:


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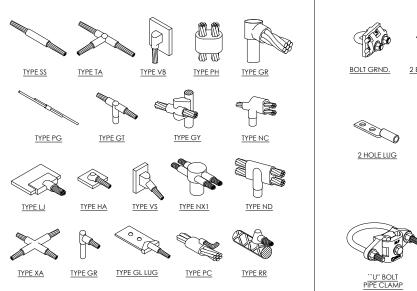
Designed By: JG Checked: RB

SINGLE LINE DIAGRAM BUSS DIAGRAM PANEL SCHEDULE

Sheet Title:

Sheet No.:



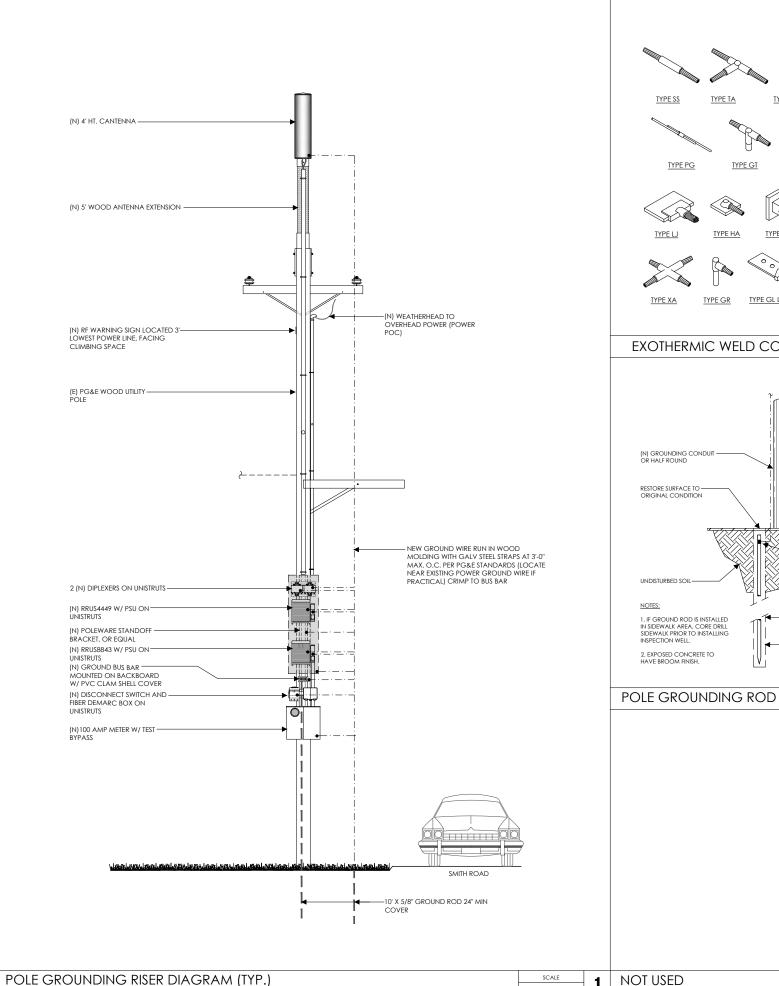





1 BOLT PARALLEL

CLAMP

MECHANICAL CONNECTION

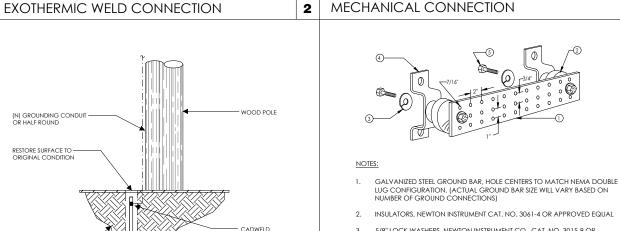

$5/8^\circ$ Lock Washers, Newton Instrument Co., Cat. No. 3015-8 or approved equal CADWELD UNDISTURBED SOIL WALL MOUNTING BRACKET, NEWTON INSTRUMENT CO., CAT NO. A-6056 OR APPROVED EQUAL NOTES: 1. IF GROUND ROD IS INSTALLED IN SIDEWALK AREA, CORE DRILL SIDEWALK PRIOR TO INSTALLING 5/8-11 X 1" HHCS BOLTS, NEWTON INSTRUMENT CO., CAT NO. 3012-1 OR APPROVED EQUAL - 3" Ø CORE DRILL FOR INSPECTION WELL. INSULATORS SHALL BE ELIMINATED WHEN BONDING DIRECTLY TO TOWER/MONOPINE STRUCTURE. CONNECTION TO TOWER/MONOPINE STRUCTURE SHALL BE PER MANUFACTURERS RECOMMENDATIONS. - 5/8" COPPER CLAD STEEL GROUND ROD 2. EXPOSED CONCRETE TO HAVE BROOM FINISH.

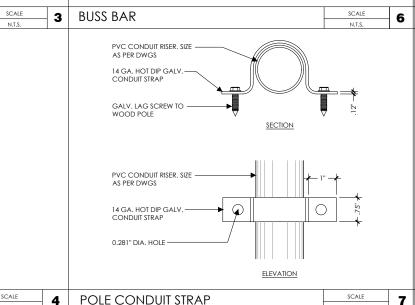

verizon /

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WIRELESS GROUP LLC

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ELECTRICAL DETAILS

Sheet No.:

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NOT USED


POLE CONDUIT STRAP


SCALE

PLAN NOTES:

- PLANS DEPICTED ARE GENERAL GUIDELINES FOR TEMPORARY VEHICULAR
 TRAFFIC CONTROL PLANS (TCP) TO INCLUDE PEDESTRIAN AND WORKER SAFETY. CONTRACTOR IS REQUIRED TO HAVE PREPARED A SITE-SPECIFIC TCP FOR REVIEW AND APPROVAL BY THE HIGHWAY AUTHORITY HAVING JURISDICTION. IF REQUIRED, THE FIRM PREPARING THE TCP SHALL BE AUTHORIZED OR CERTIFIED BY THE AUTHORITY HAVING JURISDICTION.
- 2. EXTEND CHANNELIZATION DEVICES INTO SHOULDER WHERE APPLICABLE.
- 3. DISTANCES AS INDICATED IN TABLE 1 SHOULD BE INCREASED FOR CONDITIONS THAT WOULD AFFECT STOPPING. DISTANCE SUCH AS DOWNGRADES OR LIMITED SIGHT DISTANCES. DISTANCES CAN BE DECREASED FOR LOW-SPEED (RESIDENTIAL) AREAS WITH APPROVAL BY THE AUTHORITY HAVING JURISDICTION. NIGHT-TIME WORK IS PROHIBITED UNLESS IT IS REQUIRED AS A CONDITION OF APPROVAL BY THE HIGHWAY AND LOCAL AUTHORITY HAVING JURISDICTION.
- 4. SHOULDER TAPERS SHOULD BE 1/3 OF THE ON-STREET TAPER LENGTH.
- 5. MAINTAIN A MINIMUM LANE WIDTH OF 10'.



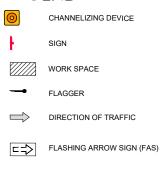

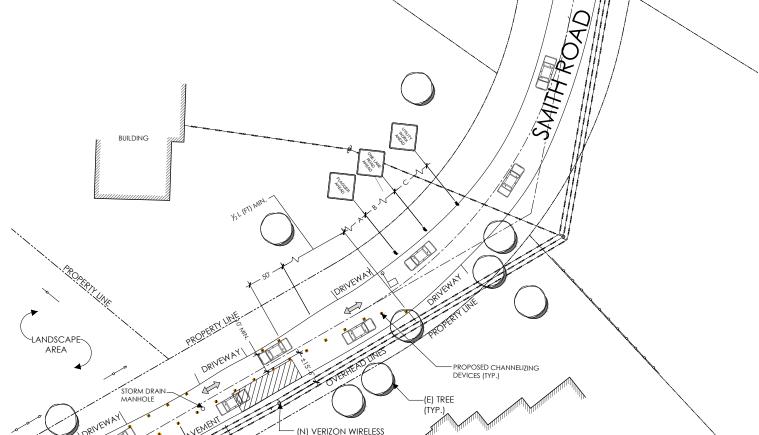

EQUIPMENT ON (E) 37.9'

LANDSCAPE-AREA

FLAGGER

PG&E WOOD UTILITY POLE

-(E) WOOD FENCE, TYP.

BUILDING

LANDSCAPE

AREA

- SIGN		7	- Flagger	2	
			TABLE 1		
POSTED SPEED (MPH)	DISTANCE BETWEEN SIGNS		TAPER	BUFFER	
	Α	В	С	L (SEE NOTE)	
15	100'	100'	100'	45'	100'
20	100'	100'	100'	80'	115'
25	100'	100'	100'	125'	155'
30	200'	200'	200'	180'	200'
35	200'	200'	200'	245'	250'
40	350'	350'	350'	320'	305'
45	350'	350'	350'	540'	360'
50	500'	500'	500'	600'	425'
55	500'	500'	500'	660'	495'
60	500'	500'	500'	720'	570'
65	500'	500'	500'	780'	645'
NOTES:					

A) DISTANCES IN FEET UNLESS OTHERWISE NOTED. B) CONTRACTOR TO VERIFY EXISTING SPEED LIMIT.

C) DISTANCES SHOWN ARE NOT VALID FOR LIMITED ACCESS HIGHWAYS. CONSULT STATE DOT MANUAL FOR DISTANCES.

D) ADJUST DISTANCES TO COMPLY WITH REQUIREMENT OF THE STATE OR LOCAL HIGHWAY AUTHORITY HAVING JURISDICTION. SEE NOTE 1, SHEET TC-2. E) TAPER LENGTHS SHOWN BASED ON 12' LANE WIDTH.



- WHEN LANE CLOSURE IS REQUIRED, THE TRAFFIC CONTROL PLAN SHOULD BE PROVIDED AND NOTARIZED BY AN INDIVIDUAL/COMPANY THAT HAS FLAGGER CONTROL TRAINING CERTIFICATION.
- "BLUE-LIGHTS" (OFF-DUTY POLICE OFFICERS) WILL BE ON SITE FOR LANE CLOSURES AND IF REQUIRED.



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(E) LIGHT POLE

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> VEHICLE TRAFFIC CONTROL PLAN

SCALE 1