SF ALAMO 013



(NEAR) 184 CREEKDALE ROAD WALNUT CREEK, CA 94595

PSL #433679

RECEIVED CONTRA COSTA COUNTY AUG 0 2 2018 Dept of Conservation & Development WAIT -00/3

SITE INFORMATION

PSL #: OWNER: 433679

PG&E CALIFORNIA JOINT POLE 870 N. MCCARTHY BLVD, SUITE 110

MILPITAS, CA 95035

APPLICANT:

VERIZON WIRELESS

2785 MITCHELL DRIVE, SUITE 9 WALNUT CREEK, CA 94598

AGENT:

SUITE 101 SONOMA, CA 95476 TEL (707) 933-9633

ON AIR LLC

APN ADJACENCY:

(ADJACENT TO) 188-132-005

SITE ADDRESS:

(NEAR) 184 CREEKDALE RD


COUNTY: ZONING: CONTRA COSTA COUNTY

CONTRA COSTA COUNTY

PUBLIC ROW

70NING JURISDICTION:



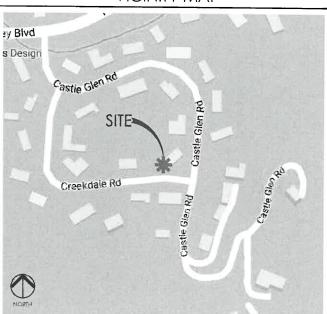

CODE COMPLIANCE

CONSTRUCTION WORKS AND MATERIALS MUST COMPLY WITH ALL APPLICABLE NATIONAL, STATE, AND LOCAL CODES AS ADOPTED BY LOCAL JURISDICTION, INCLUDING BUT NOT LIMITED TO:

- CALIFORNIA CODE OF REGULATIONS
- 2016 CALIFORNIA BUILDING CODE 2016 CALIFORNIA MECHANICAL CODE 2016 CALIFORNIA PLUMBING CODE 2016 CALIFORNIA ELECTRIC CODE

- 2016 EDITION OF TITLE 24 ENERGY STANDARDS
- ANY LOCAL BUILDING CODE AMENDMENTS TO THE ABOVE
- CITY / COUNTY ORDINANCES
 2016 CALIFORNIA FIRE CODES WITH ALL LOCAL AMENDMENTS
 GO 95 REGULATIONS

DRIVING DIRECTIONS

DIRECTIONS FROM VERIZON WIRELESS RF MARKET OFFICE:

- HEAD NORTH-EAST ON MITCHELL DR TOWARDS OAK GROVE RD
- TURN LEFT ONTO OAK GROVE RD
 USE THE LEFT 2 LANES TO TURN LEFT ONTO TREAT BLVD
- TURN RIGHT ONTO N MAIN ST TURN RIGHT ONTO THE INTERSTATE 680 S SLIP ROAD TO OAKLAND/SAN JOSE
- MERGE ONTO 1-680 S
- TAKE EXIT 45B FOR OLYMPIC BLVD TURN RIGHT ONTO OLYMPIC BLVD
- USE THE LEFT 2 LANES TO TURN LEFT ONTO TICE VALLEY BLVD
- TURN RIGHT ONTO CREEKDALE RD

PROJECT TEAM

ON AIR, LLC

ON AIR LLC 465 FIRST ST. WEST SONOMA, CA 95476

PROJECT MGR: CHRIS FOWLER

MOBILE: (650) 888-0809 (707) 933.9633 cfowler@onairllc.com

CONSTRUCTION MANAGER: MOHAMMAD A. BASEER

MOBILE: (510) 414.7075

SITE ACQUISITION MGR: PETE HILLIARD

MOBILE: (707) 732.7227 OFFICE: (707) 933.9633 EMAIL: philliard@onairllc.com

ARCHITECT/ENGINEER

PROJECT MANAGER: RODNEY BARNES

MERIDIAN MANAGEMENT, INC. EMAIL: rodney@meridian.managemen

VERIZON WIRELESS

VERIZON WIRELESS BUILDING 9 WALNUT CREEK, CA 94598

HANDICAP REQUIREMENTS

FACILITY IS UNMANNED AND NOT FOR HUMAN HABITATION. HANDICAPPED ACCESS NOT REQUIRED IN ACCORDANCE WITH CALIFORNIA ADMINISTRATIVE STATE CODE PART 2, TITLE 24, CHAPTER 11B, SECTION 1103B.



PROJECT DESCRIPTION

THIS IS AN UNMANNED TELECOMMUNICATIONS FACILITY FOR THE VERIZON WIRELESS NETWORK CONSISTING OF THE INSTALLATION AND OPERATION OF AN ANTENNA AND ASSOCIATED EQUIPMENT ON AN EXISTING WOOD POLE IN THE PUBLIC RIGHT-OF-WAY.

- INSTALL NEW TELECOMMUNICATIONS EQUIPMENT BOXES ON A 38.4" HT. PG&E WOOD
- 2. POLE-MOUNTED EQUIPMENT TO BE INSTALLED ON A GO95 COMPLIANT STANDOFF
- EQUIPMENT CONSISTS OF (1) 2' HT. CANTENNA ON 7' POLE TOP EXTENSION,
- POLE-MOUNTED STANDOFF BRACKET W/ DISCONNECT SWITCH, AND GROUND BUSS BAR. INSTALL (1) RRU4449, (1) RRU8843, (2) DIPLEXERS, (2) POWER SUPPLY UNITS, (6) HYBRID COMBINERS, AND (1) POWER METER INSIDE FENCED SCREENING ENCLOSURE, (1) CHRISTY PULL BOX (IF REQUIRED).
- INSTALL POLE STEPS AS REQUIRED
- ALL POLE EQUIPMENT TO BE PAINTED WITH VALSPAR 'DEEP EARTH' COLOR. POWER SERVICE FROM OVERHEAD POC

DRAWING INDEX

SHEET NO:	SHEET TITLE
T.1	TITLE SHEET
C.1	SITE SURVEY
C.2	SITE SURVEY
A.1	OVERALL SITE PLAN
A.2	POLE PLAN ENLARGEMENTS
A.3	ELEVATIONS
A.4	ELEVATIONS
A.5	EQUIPMENT DETAILS
A.6	EQUIPMENT DETAILS
A.7	EQUIPMENT DETAILS
E.1	SINGLE LINE DIAGRAM, BUSS DIAGRAM, PANEL SCHEDULE
E.2	POLE GROUNDING, ELECTRICAL DETAILS
TC.1	SITE SPECIFIC VEHICLE TRAFFIC CONTROL PLAN

ADMINISTRATIVE REQUIREMENTS

Contractor shall verify all plans & (e) dimensions & conditions on THE JOB SITE & SHALL IMMEDIATELY NOTIFY THE ENGINEER IN WRITING OF ANY DISCREPANCIES BEFORE PROCEEDING WITH THE WORK OR BE RESPONSIBLE FOR SAME IF USING 11"X17" PLOT, DRAWINGS WILL BE HALF SCALE

verizon/

Verizon Wireless 2785 Mitchell Drive, Suite 9 Walnut Creek, CA 94598



785 Oak Grove Road F2 Suite 251 Concord, CA 94518 T 707,592,5924

Project Architect:



100% Construction Drawings

Drawing Phase:

SF ALAMO 013

(NEAR) 184 CREEKDALE RD WALNUT CREEK, CA 94595

PSI #433679

Professional Seal:

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01	07/08/17	Constr. Dwgs 90%
02	08/07/17	Constr. Dwgs 100%
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05	06/04/18	Constr. Dwgs 100%

Project No.:

Date: 06/04/18 Job No.:


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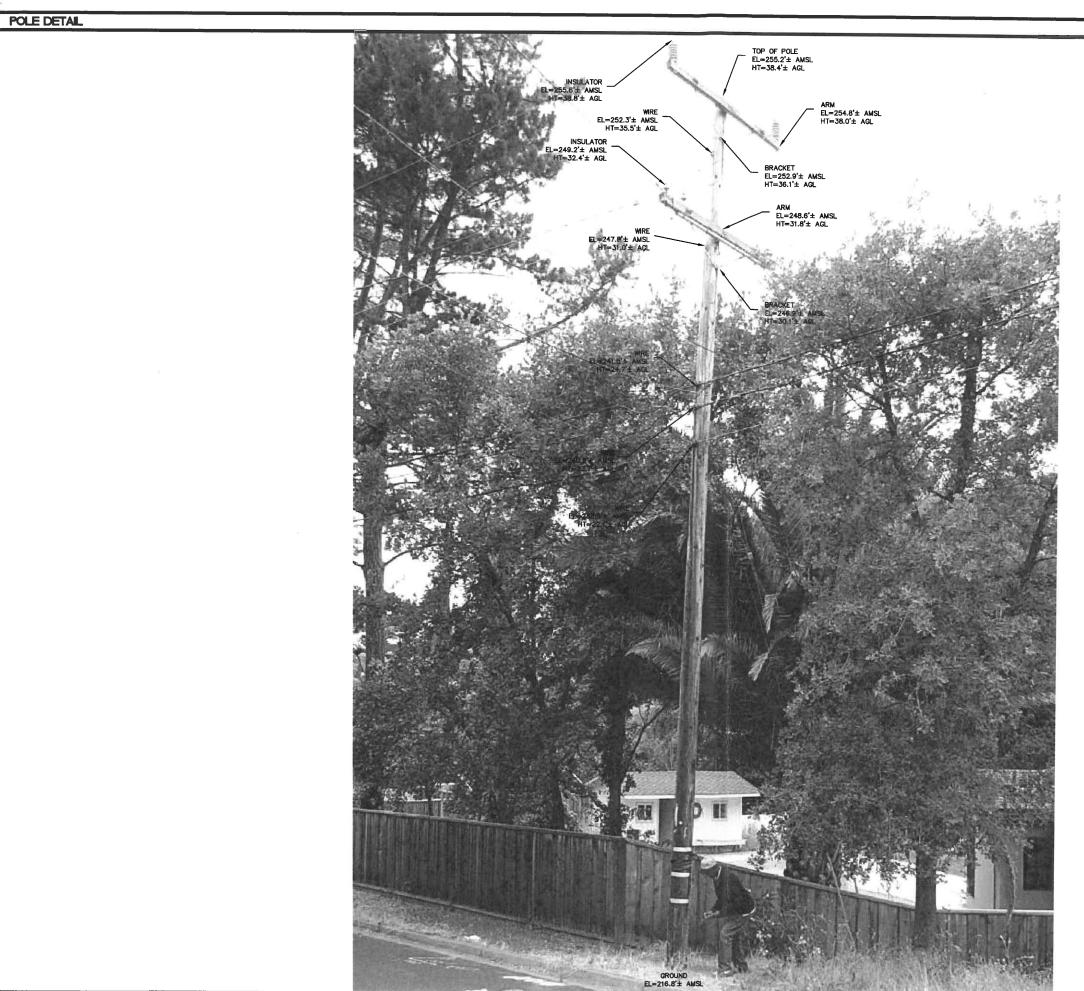
Designed By: JG Checked:

TITLE SHEET

Sheet Title:

Sheet No.:



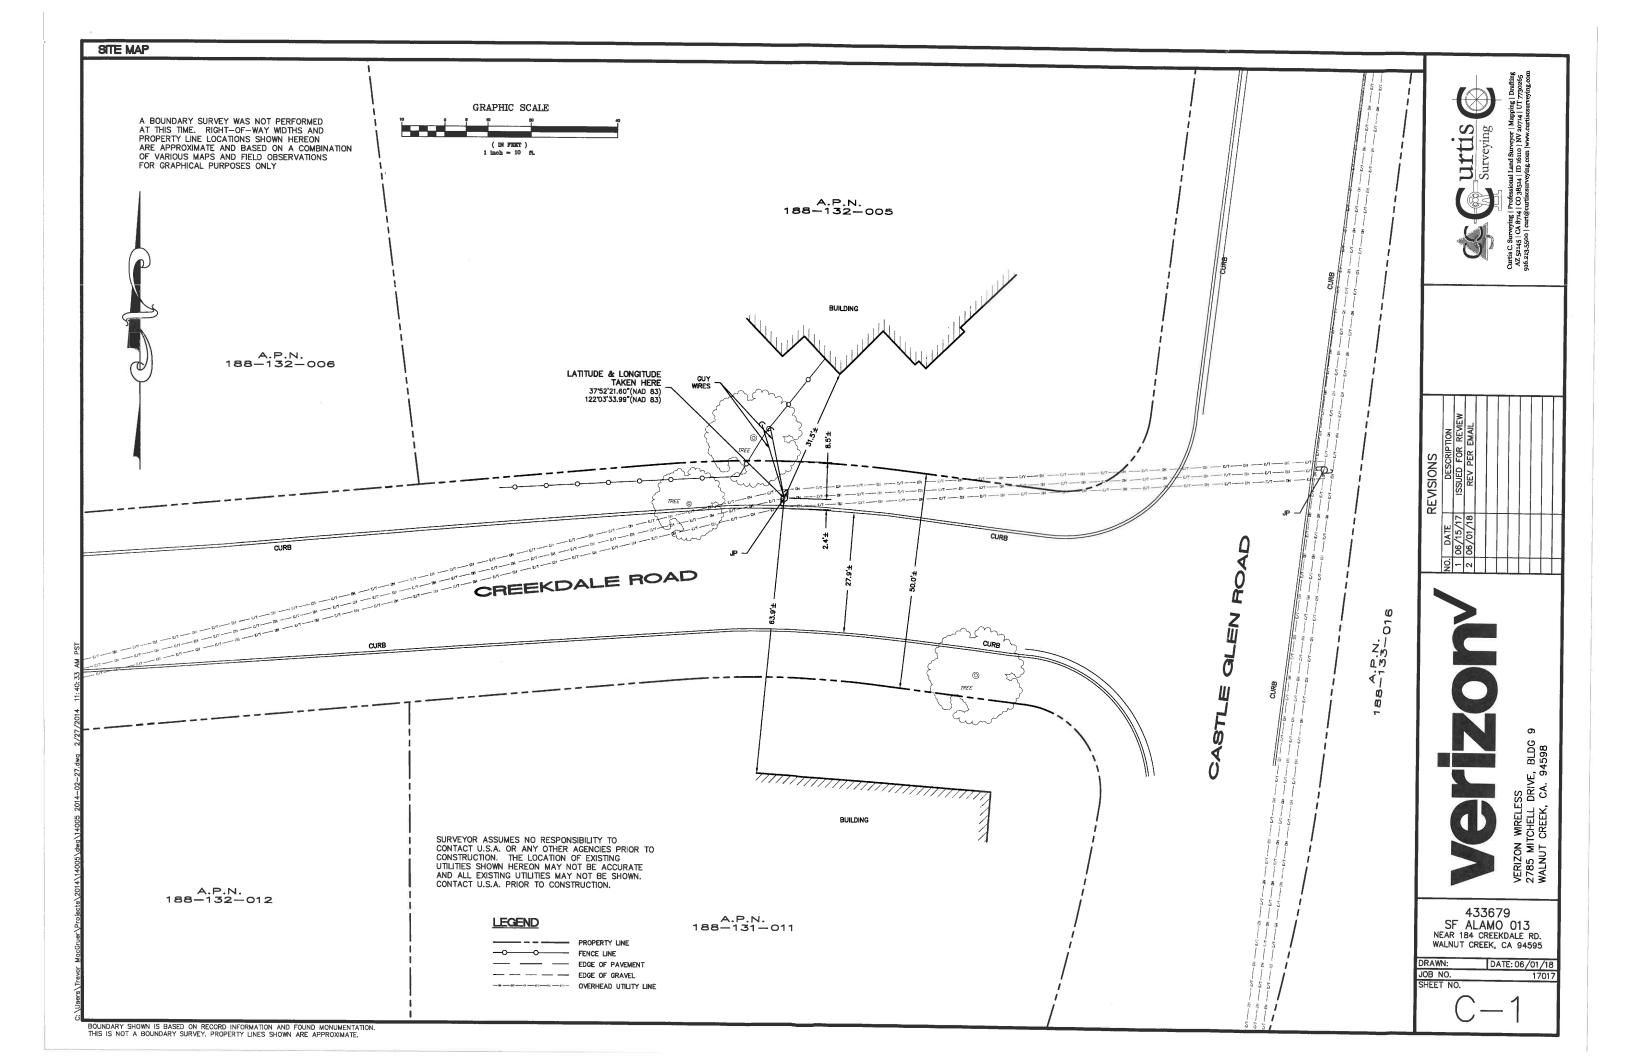

NOT TO SCALE






433679 SF ALAMO 013 NEAR 184 CREEKDALE RD. WALNUT CREEK, CA 94595

DRAWN: JOB NO. SHEET NO. DATE: 06/01/18

LEGEND

ABOVE GROUND LEVEL ABOVE MEAN SEA LEVEL

BOUNDARY SHOWN IS BASED ON RECORD INFORMATION AND FOUND MONUMENTATION. THIS IS NOT A BOUNDARY SURVEY. PROPERTY LINES SHOWN ARE APPROXIMATE.

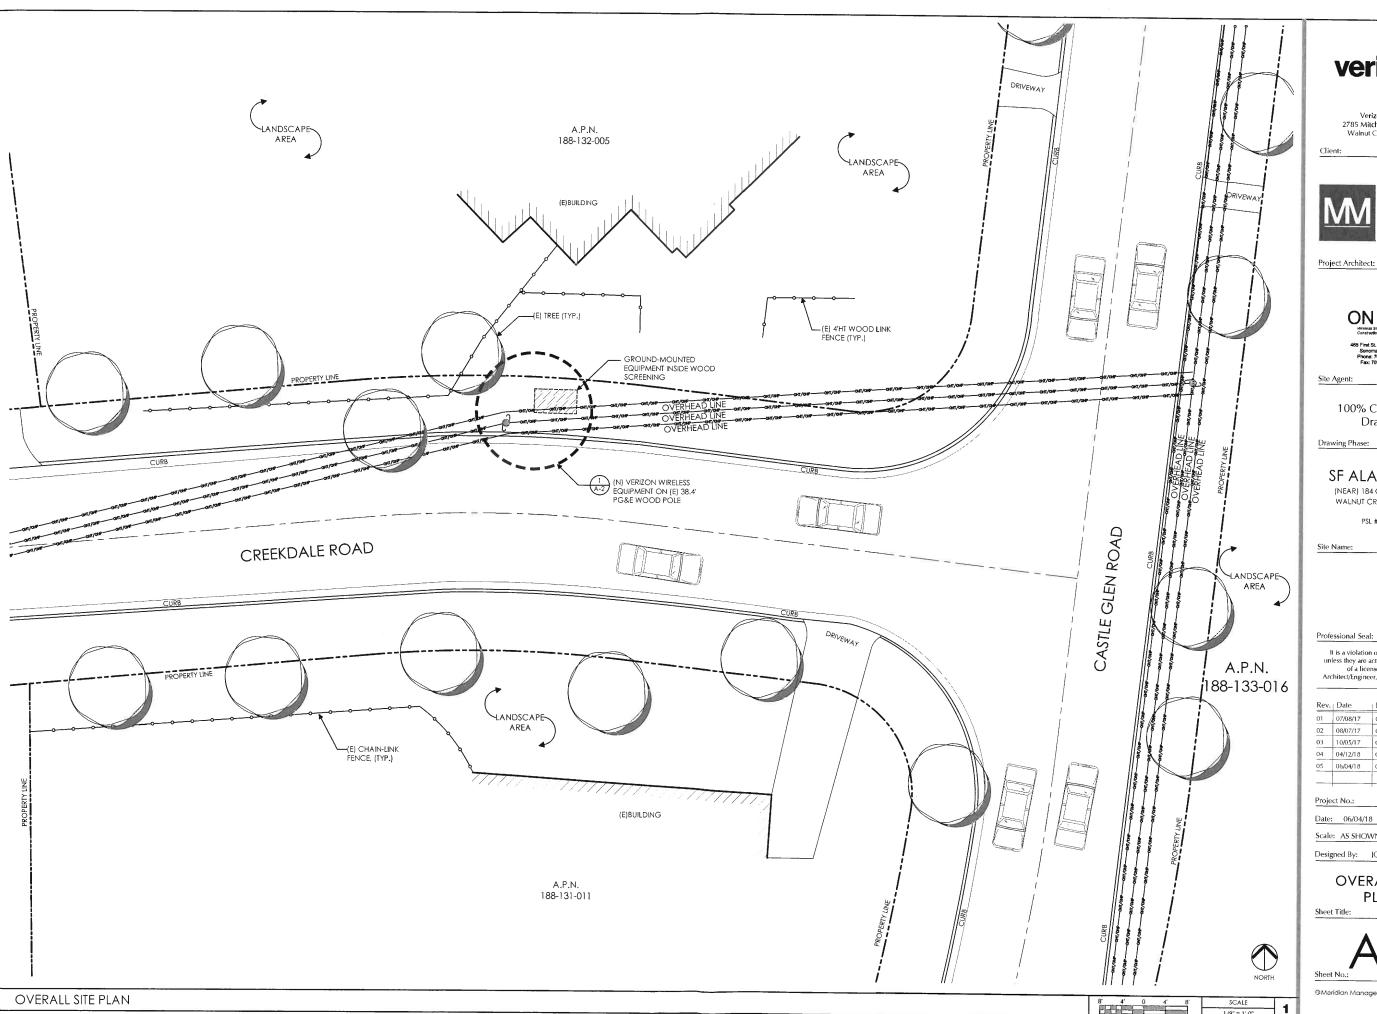

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100% Construction Drawings

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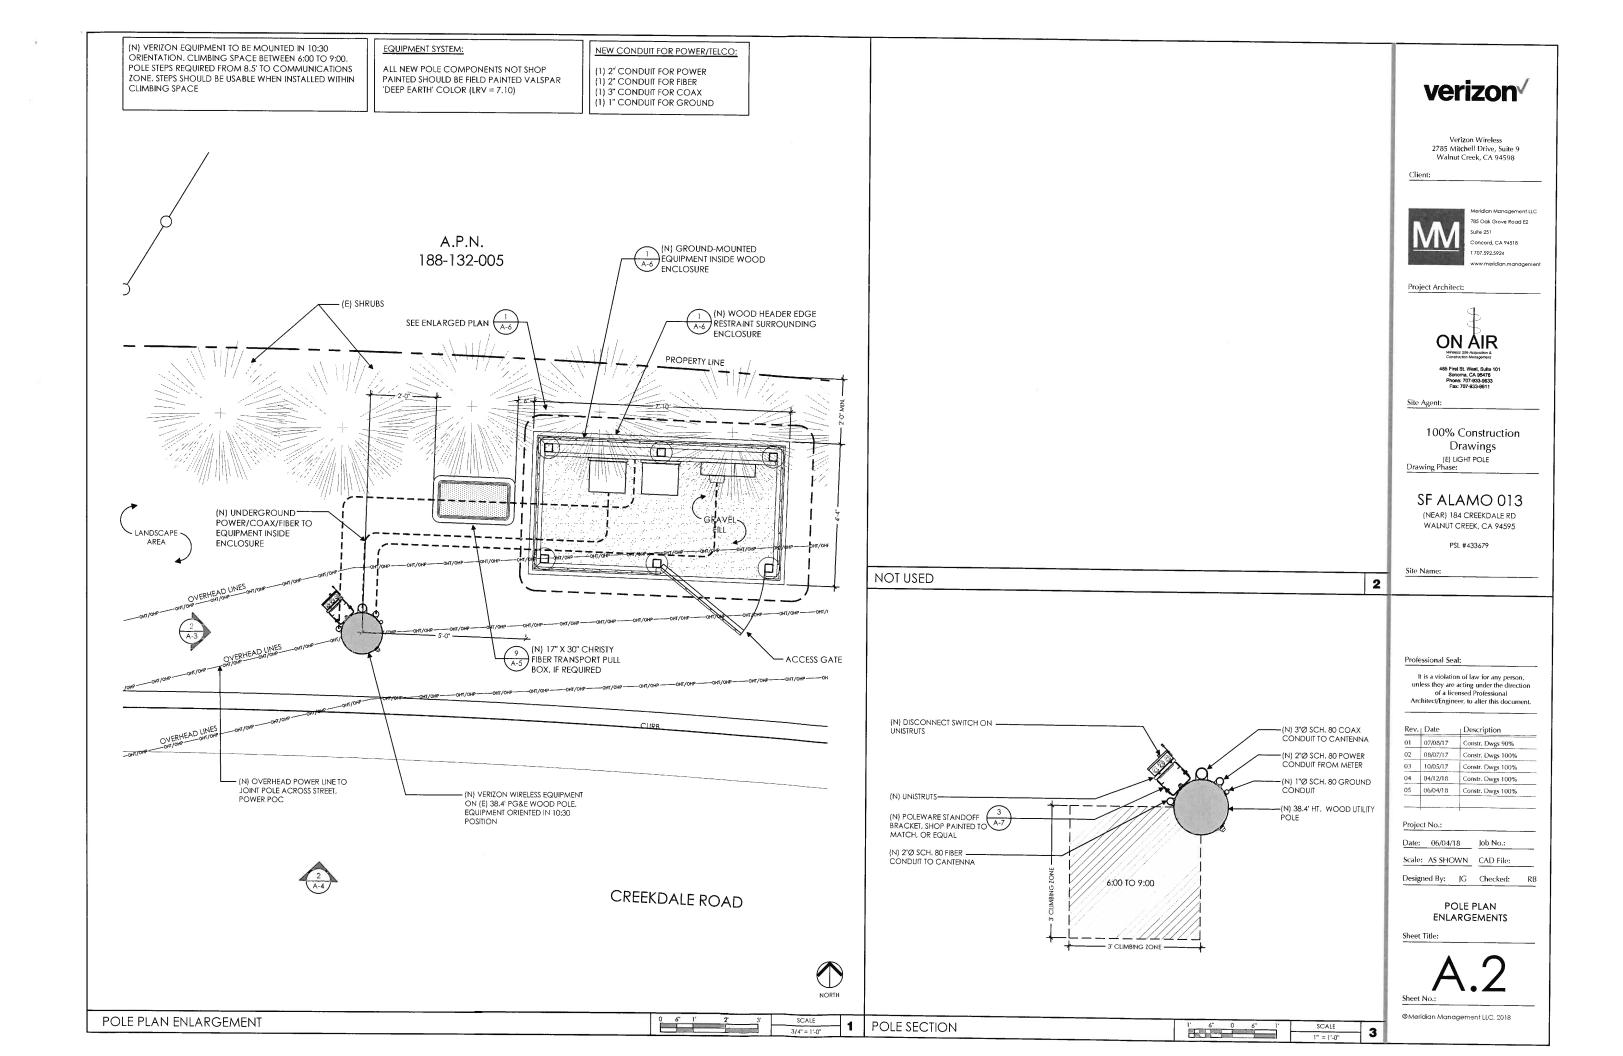
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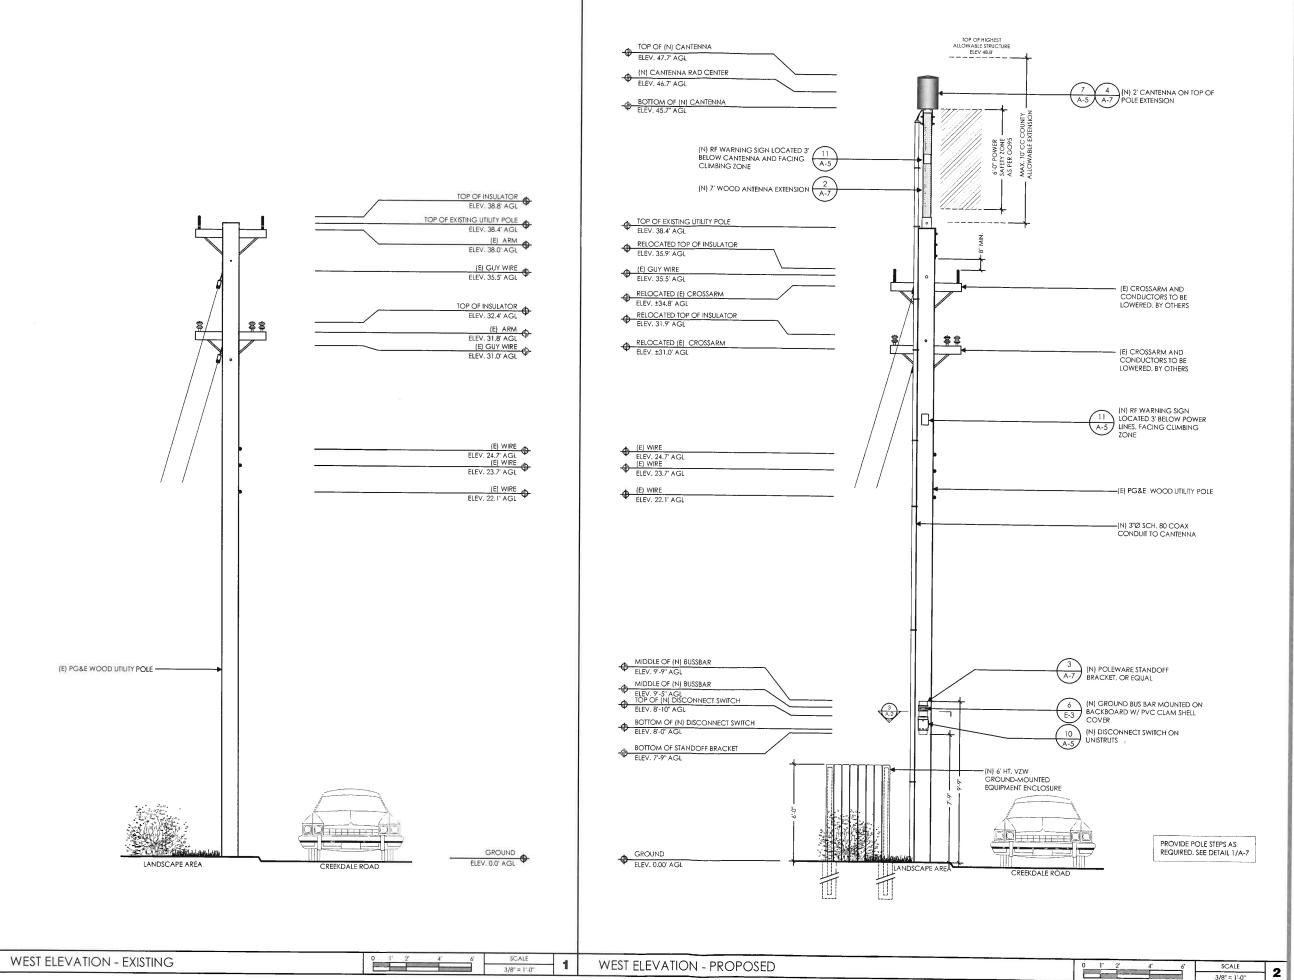
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Designed By: JG Checked: RB

OVERALL SITE







Verizon Wireless 2785 Mitchell Drive, Suite 9 Walnut Creek, CA 94598

Client:



785 Oak Grove Road E2 Suite 251 Concord, CA 94518

Project Architect:



485 First St. West, Suite Sonoma, CA 95476 Phone: 707-933-963 Fax: 707-933-9611

Site Agent:

100% Construction Drawings

Drawing Phase:

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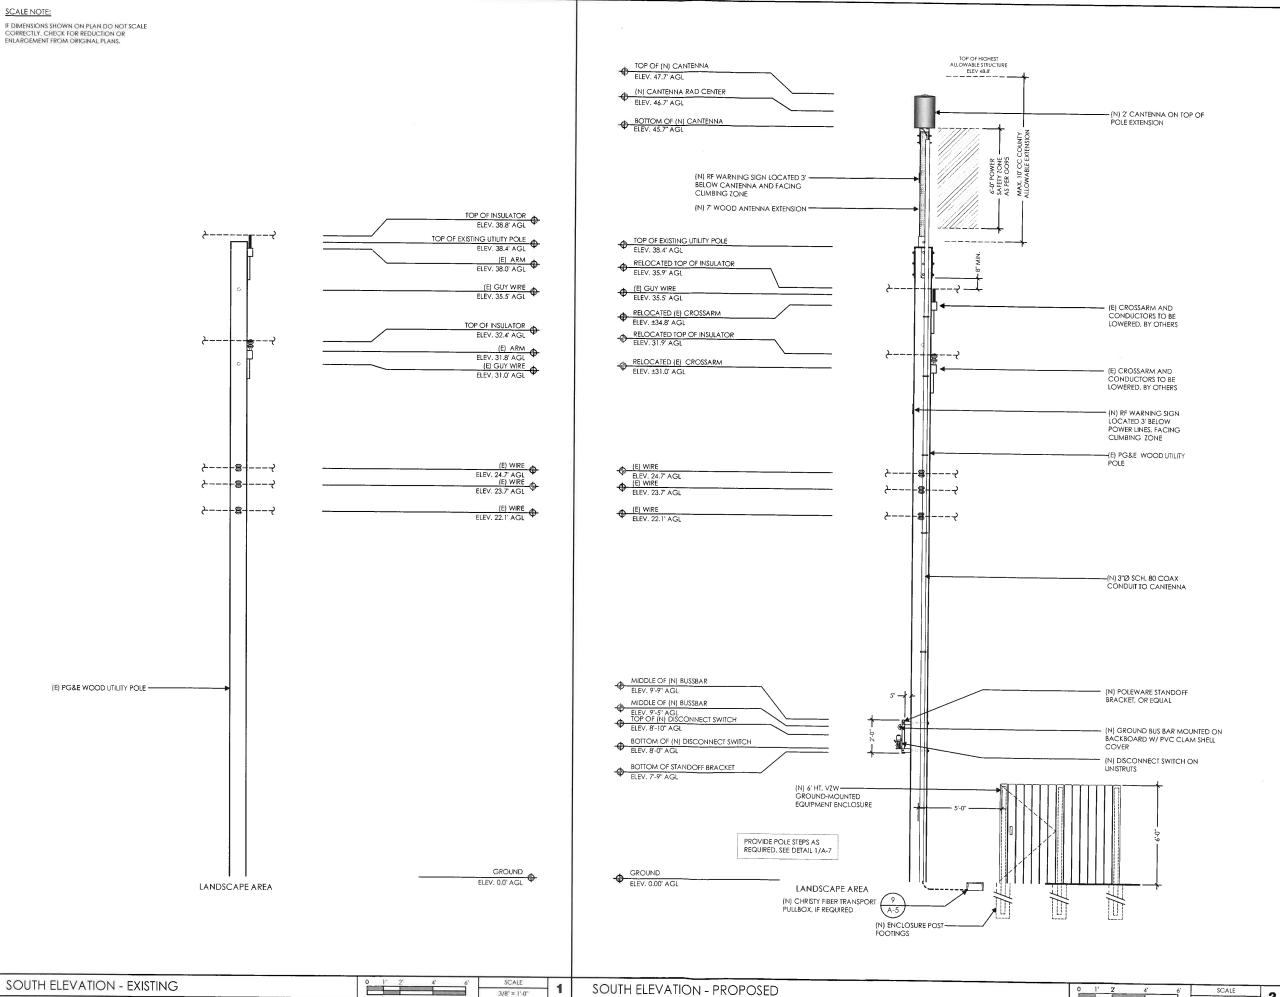
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ELEVATIONS

Sheet Title:

A.3

Sheet No.:





Verizon Wireless 2785 Mitchell Drive, Suite 9 Walnut Creek, CA 94598



785 Oak Grove Road E2 Suite 251 Concord, CA 94518 707.592.5924

Project Architect:



465 First St. West, Suite 101 Sonoma, CA 95476 Phone: 707-933-9633 Fax: 707-933-9611

Site Agent:

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Drawing Phase:

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ELEVATIONS

Sheet Title:

Sheet No.:

2

ERICSSON RRUS4449 B5 B13 W/


PROTRUDING ITEMS

HEIGHT: 18 INCHES

WIDTH: 13.2 INCHES

LENGTH: 9.4 INCHES

WEIGHT: 70 LBS (EXCLUDES MOUNTING HARDWARE)

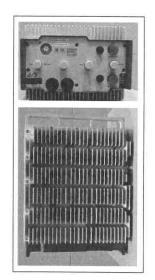


ERICSSON RRUS8843 W/ PROTRUDING ITEMS


HEIGHT: 18 INCHES

WIDTH: 13.2 INCHES

DEPTH: 11.3 INCHES

WEIGHT: 75 LBS

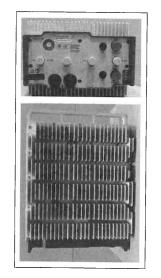

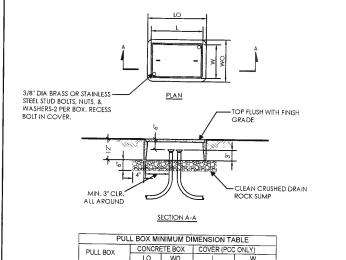

LO WO 30" 17" 25-3/8" 13-1/4" PULL BOX 9

RRUS4449

RRUS8843

HEIGHT: 24.0 INCHES


DIAMETER: 14.6 INCHES

WEIGHT: 22.1 LBS (WITH MOUNTING

BRACKET)



6

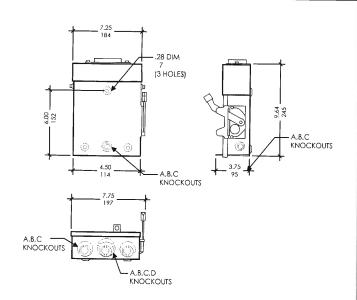

DEPTH: 7.0 INCHES

DIPLEXER

WEIGHT: 4.4 LBS

HEIGHT: 8.31 INCHES

WIDTH: 2.48 INCHES

POWER SUPPLY UNIT (PSU) 2

CANTENNA

NOTE: NEW PHENOLIC SIGN ATTACHED TO EXTERIOR PANEL

SCALE

DISCONNECT SWITCH

CONTRACTOR NOTE: SITE ID WILL BE SITE ID, MARKET ID,

- NEMA 3R RAIN COVER

OUTSIDE PANEL DOOR

SITE #, AND SITE NAME

UNIT: 100 AMP METER W/ TEST BYPASS

HEIGHT: 24 INCHES WIDTH: 24 INCHES

DEPTH: 4-5/8 INCHES

ELECTRIC METER



3X3 HYBRID COMBINER UNIT:


PSU AC 08 (100-250 V AC)

LONG: 6.85 INCHES

WIDTH: 3.2 INCHES

THICKNESS: 1.48 INCHES



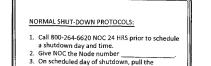

SHOWING DISCONNECT SWITCH a shutdown day and time.
2. Give NOC the Node number
3. On scheduled day of shutdown, pull the disconnect handle to the "OFF" position
4. Call NOC when work is completed. TELCO POWER DISCONNECT SWITCH EMERGENCY SHUT-DOWN PROTOCOLS: 1. Call 800-264-6620 NOC immediately. 2. Give NOC the Node number
3. Pull the disconnect handle to the "OFF" position.
4. Call NOC when work is completed. - DISC. OR PANEL DOOR W/ LATCH-LOOP (LOCKABLE)

ON WOOD POLES - SIGN ON ALUMINUM WITH SS SCREW TO THE POLE 3' BELOW ANTENNA

SIGN PLACEMENT:
AFFIX TO THE STRUCTURE 3-4" BELOW THE COMMERCIAL RF ANTENNA (S) OR
3" BELOW LOWEST POWER WIRE

SIGN COLOR: YELLOW

CONTRACTOR NOTE: SITE ID WILL BE SITE ID, MARKET ID, SITE #, AND SITE NAME

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Verizon Wireless

2785 Mitchell Drive, Suite 9

Walnut Creek, CA 94598

785 Oak Grove Road E2 Suite 251 Concord, CA 94518

707.592.5924

ON AIR

100% Construction

Drawings

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EQUIPMENT

DETAILS

Project Architect:

Site Agent:

Drawing Phase:

Site Name:

Professional Seal:

Rev. | Date

Project No.:

Sheet Title

10


Meridian Management LLC, 2018

HYBRID COMBINER


DISCONNECT SIGNAGE


RF WARNING SIGNAGE

11

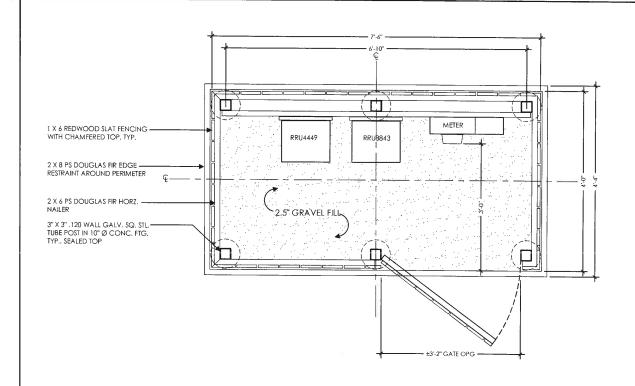

PLAN VIEW

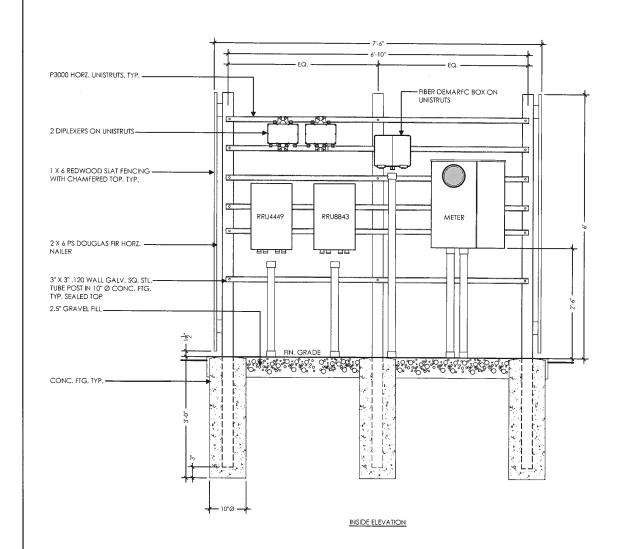

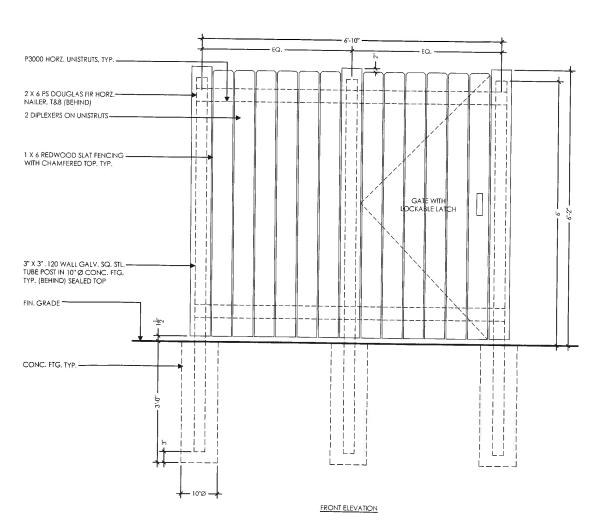



Verizon Wireless 2785 Mitchell Drive, Suite 9 Walnut Creek, CA 94598

Client:



Meridian Management LLC 785 Oak Grove Road E2 Suite 251 Concord, CA 94518 T 707.592.5924

Project Architect:



465 First St. West, Suite 11 Sonoma, CA 95476 Phone: 707-933-9633

Site Agent:

100% Construction Drawings

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EQUIPMENT DETAILS

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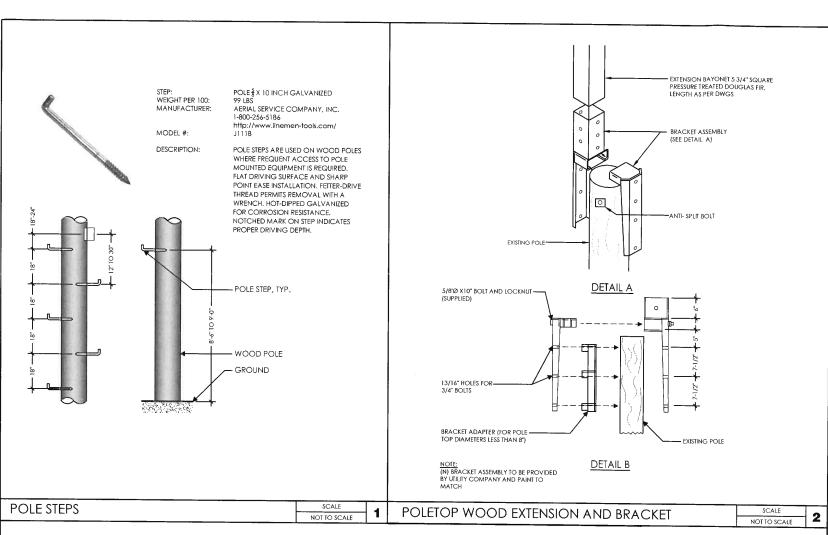
A.6


Sheet No.:

Meridian Management LLC, 2018

WOOD ENCLOSURE DETAILS

1' 6" 0 6" 1' SCALE



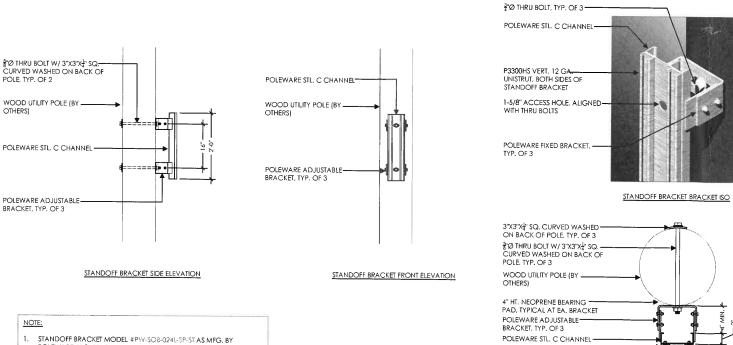


P3300HS 12 GA, VERT, UNISTRUT

CHANNELS, BOTH SIDES OF STANDOFF BRACKET

P3300HS HORIZ. UNISTRUT — CHANNELS FOR EQUIPMENT

ATTACHMENT, BY OTHERS. CUT TO FIT. INSTALL W/ CHANNEL NUTS W/ SPRINGS.

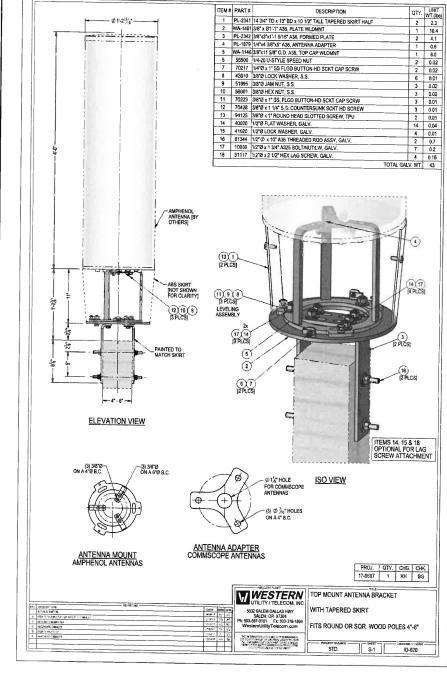

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785 Oak Grove Road E2 Concord, CA 94518 707.592.5924

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Meridian Management LLC, 2018

STANDOFF BRACKET

POLEWARE, LLC, (475) 215-5119, OR EQUAL ALL COMPONENTS TO BE SHOP PRIMED PAINTED


UNISTRUT COMPONENTS TO BE MFG BY UNISTRUT CORPORATION, 1140
W. THORNDALE AVE., ITASCA IL, 60143, (800) 468-9510.

HORIZONTAL UNISTRUTS (P3300HS) FOR EQUIPMENT INSTALLATION NOT

ADJUSTABLE BRACKETS FOR SLANTED POLES AVAILABLE BY SPECIAL

STANDOFF BRACKET PLAN

CANTENNA ATTACHMENT BRACKET

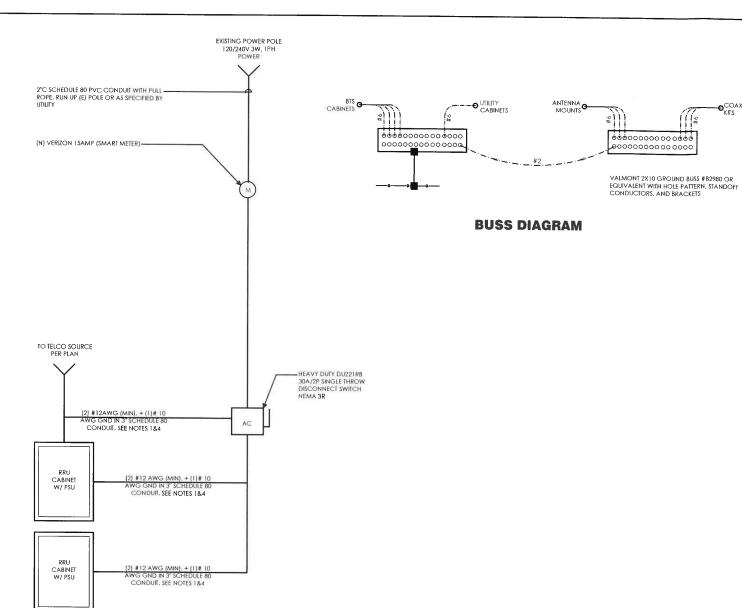

POWER AND TELCO NOTES:

- POWER AND TELCO POINTS OF CONNECTION AND ANY EASEMENTS ARE PRELIMINARY AND SUBJECT TO CHANGE BY THE UTILITY COMPANIES.
- CONTRACTOR SHALL COORDINATE WITH UTILITY COMPANY FOR FINAL AND EXACT WORK/MATERIALS REQUIREMENTS AND CONSTRUCT TO UTILITY ENGINEERING PLANS AND SPECIFICATIONS ONLY WHERE APPLICABLE PER PROJECT SCOPE OF WORK.
- CONTRACTOR SHALL FURNISH AND INSTALL CONDUIT, PULL WIRES, CABLE PULL BOXES, CONCRETE ENCASEMENT OF CONDUIT, TRANSFORMER PAD, BARRIERS, POLE RISER TRENCHING, BACK FILL, AND UTILITY FEES, AND INCLUDE REQUIREMENTS IN SCOPE.
- 4. CONTRACTOR SHALL LABEL ALL MAIN DISCONNECT SWITCHES AS REQUIRED BY CODE.


NOI

- SUBCONTRACTOR SHALL PROVIDE METER WITH DIST. PANEL AND BREAKERS FOR POWER TO THE BTS, UNITS AND THE BTS/UTILITY CABINET.
- 2. ALL SERVICE EQUIPMENT AND INSTALLATIONS SHALL COMPLY WITH THE N.E.C. AND UTILITY COMPANY AND LOCAL CODE REQUIREMENTS.
- SUBCONTRACTOR SHALL PROVIDE ELECTRICAL SERVICE ENTRANCE EQUIPMENT WITH FAULT CURRENT RATINGS GREATER THAN THE AVAILABLE FAULT CURRENT FROM THE POWER UTILITY.
- 4. FIELD ROUTE CONDUIT TO CABINETS AS REQUIRED.
- 5. MAXIMUM ONE WAY CIRCUIT RUN NOT TO EXCEED 75 FEET.

GENERAL ELECTRICAL NOTES:


- PROVIDE ALL ELECTRICAL WORK & MATERIALS AS SHOWN ON THE DWGS. AS CALLED FOR HEREIN, & AS IS NECESSARY TO FURNISH A
 COMPLETE INSTALLATION.
- THE INSTALLATION SHALL CONFORM TO THE REQUIREMENTS OF THE CURRENT ADOPTED CALIFORNIA ELECTRICAL CODE, STATE OF
 CALIFORNIA TITLE24, ALL OTHER APPLICABLE CODES AND ORDINANCES & THE REQUIREMENTS OF THE FIRE MARSHALL. ALL EQUIPMENT
 & WIRING SHALL BEAR THE APPROVAL STAMP OF UNDERWRITERS LABORATORY (UL) OR AN APPROVED TESTING LABORATORY,
 PAYMENT FOR ALL INSPECTION FEES AND PERMITS ARE PART OF THIS CONTRACT.
- 3. THE CONTRACTOR SHALL BE RESPONSIBLE FOR THE SAFETY AND GOOD CONDITION OF ALL MATERIALS & EQUIPMENT FOR THE ENTIRE INSTALLATION & UNIT COMPLETION OF WORK, ERECT & MAINTAIN APPROVED & SUITABLE BARRIERS, PROTECTIVE DEVICES & WARNING SIGNS, BE FULLY RESPONSIBLE FOR ANY LOSS OR INJURY TO PERSONS OR PROPERTY RESULTING FROM NEGLIGENCE AND/OR ENFORCEMENT OF ALL SAFETY PRECAUTIONS & WARNINGS.
- 4. COORDINATE THE ELECTRICAL INSTALLATION WITH ALL OTHER TRADES
- 5. ALL SAW CUTTING, TRENCHING, BACK FILLING & PATCHING SHALL BE PART OF THIS CONTRACT.
- 6. FINALIZE ALL ELECTRICAL SERVICE ARRANGEMENTS. INCLUDING VERIFICATION OF LOCATIONS, DETAILS, COORDINATION OF THE INSTALLATION & PAYMENT OF ACCRUED CHARGES WITH LOCAL POWER COMPANY, VERIFY LOCATION FOR FACILITIES & DETAILS WITH POWER UTILITY, IN ADDITION TO THE REQUIREMENTS SHOWN IN THE CONTRACT DOCUMENTS, WORK SHALL COMPLY WITH CONSTRUCTION STANDARDS & SERVICE REQUIREMENTS OF THE RESPECTIVE UTILITIES, INCLUDING ANY SUPPLEMENTAL DWGS ISSUED & SHALL BE SUBJECT TO APPROVAL OF THESE UTILITIES.
- ALL WIRING SHALL BE COPPER. INSULATION FOR BRANCH CIRCUIT CONDUCTORS SHALL BE TYPE "THWN" CONDUCTORS LARGER AND #6 AWG MAY BE TYPE "THWN" OR "TWN".
- 8. PROVIDE CONDUIT SEALS FOR ALL CONDUITS PENETRATING WEATHERPROOFING OR WEATHERPROOF ENCLOSURE ENVELOPE. MASTIC SEAL ALL CONDUIT OPENING PENETRATIONS COMPLETELY WATERTIGHT.
- UNLESS SHOWN OTHERWISE, FUSED DISCONNECT SWITCHES SHALL BE PROVIDED WITH LOW-PEAK, S\DUAL ELEMENT FUSES SIZED TO EQUIPMENT NAMEPLATE FUSE CURRENT RATING. MOTOR STARTERS SHALL BE PROVIDED WITH SIMILARLY SIZED FUSIBLE ELEMENTS, SWITCHES AND OTHER OUTDOOR EQUIPMENT SHALL BE RATED NEMA 3R AND/OR UL LISTED FOR WET ENVIRONMENT.
- 10. THE CONTRACTOR SHALL BE RESPONSIBLE FOR TESTING THE GROUNDING SYSTEM AND ENSURING A 5 OHM OR LESS GROUNDING PATH, ADDITIONAL GROUND RODS AND/OR CHEMICAL ROD SYSTEM SHALL BE USED TO ACHIEVE THIS REQUIREMENT IF THE GIVEN DESIGN CANNOT BE MADE TO ACHIEVE THIS REQUIREMENT.


NEW LOAD: NEW TOTAL LOAD

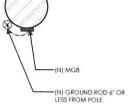

SINGLE LINE DIAGRAM

GROUNDING PLAN

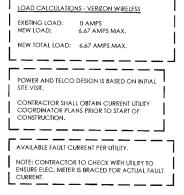

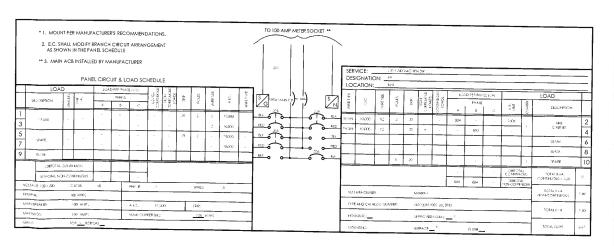

PANEL SCHEDULE -- PANEL " PP "

verizon /

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Scale: AS SHOWN CAD File:

Designed By: JG Checked: RB


SINGLE LINE DIAGRAM
BUSS DIAGRAM

PANEL SCHEDULE

Sheet Title:

E.1

Sheet No.:

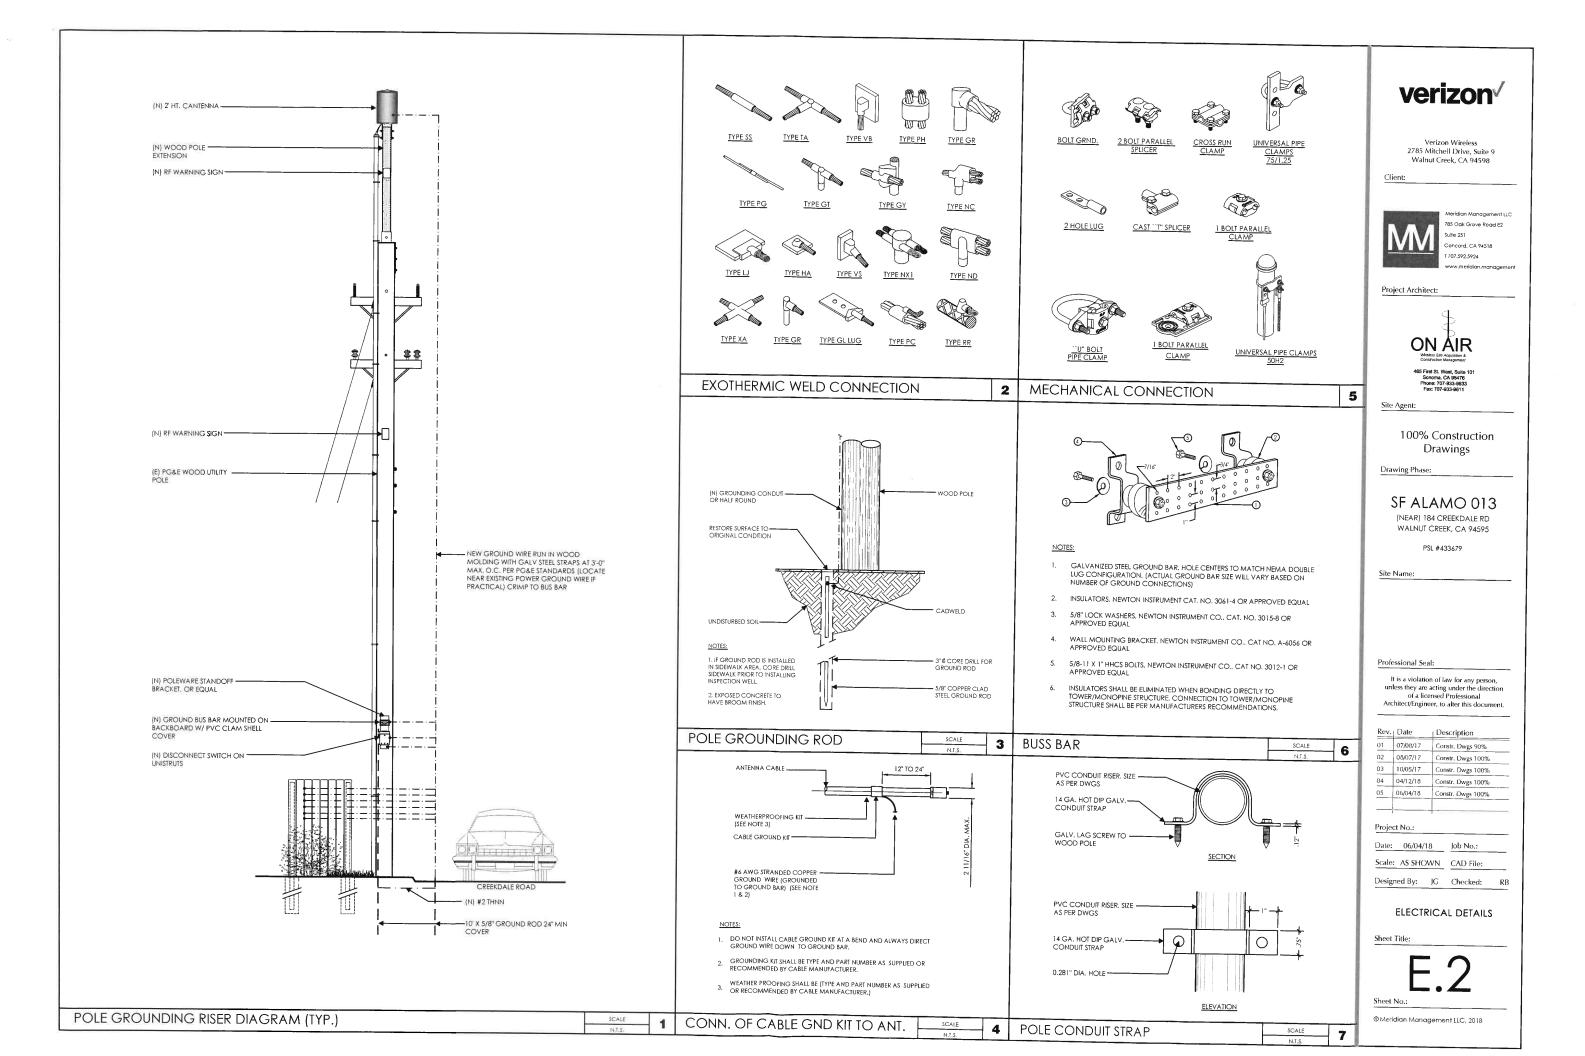

PLAN NOTES:

- PLANS DEPICTED ARE GENERAL GUIDELINES FOR TEMPORARY VEHICULAR
 TRAFFIC CONTROL PLANS (TCP) TO INCLUDE PEDESTRIAN AND WORKER SAFETY. CONTRACTOR IS REQUIRED TO HAVE PREPARED A SITE-SPECIFIC TOP FOR REVIEW AND APPROVAL BY THE HIGHWAY AUTHORITY HAVING JURISDICTION. IF REQUIRED, THE FIRM PREPARING THE TCP SHALL BE AUTHORIZED OR CERTIFIED BY THE AUTHORITY HAVING JURISDICTION.
- 2. EXTEND CHANNELIZATION DEVICES INTO SHOULDER WHERE APPLICABLE.
- 3. DISTANCES AS INDICATED IN TABLE 1 SHOULD BE INCREASED FOR CONDITIONS THAT WOULD AFFECT STOPPING, DISTANCE SUCH AS DOWNGRADES OR LIMITED SIGHT DISTANCES. DISTANCES CAN BE DECREASED FOR LOW-SPEED (RESIDENTIAL) AREAS WITH APPROVAL BY THE AUTHORITY HAVING JURISDICTION. NIGHT-TIME WORK IS PROHIBITED UNLESS IT IS REQUIRED AS A CONDITION OF APPROVAL BY THE HIGHWAY AND LOCAL AUTHORITY HAVING JURISDICTION.
- 4. SHOULDER TAPERS SHOULD BE 1/3 OF THE ON-STREET TAPER LENGTH.
- 5. MAINTAIN A MINIMUM LANE WIDTH OF 10'.

LEGEND


WORK SPACE

FLAGGER

DIRECTION OF TRAFFIC

FLASHING ARROW SIGN (FAS)

CHANNELIZING DEVICE

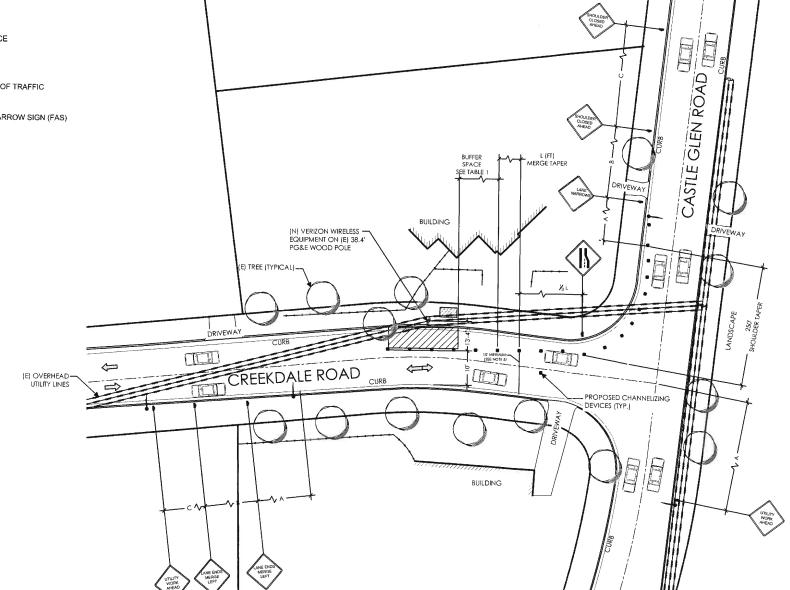



SIGN



			TABLE 1		
POSTED SPEED (MPH)		DISTANCI BETWEEN SIGNS	_	TAPER	BUFFER
	A	В	С	L (SEE NOTE)	
15	100'	100'	100'	45'	100'
20	100'	100'	100'	80'	115'
25	100'	100'	100'	125'	155
30	200'	200'	200'	180'	200'
35	200'	200'	200'	245'	250'
40	350'	350'	350'	320'	305'
45	350'	350'	350'	540'	360'
50	500'	500'	500'	600'	425'
55	500'	500'	500'	660'	495'
60	500'	500'	500'	720'	570'
65	500'	500'	500'	780'	645'

A) DISTANCES IN FEET UNLESS OTHERWISE NOTED. B) CONTRACTOR TO VERIFY EXISTING SPEED LIMIT.

C) DISTANCES SHOWN ARE NOT VALID FOR LIMITED ACCESS HIGHWAYS. CONSULT STATE DOT MANUAL FOR DISTANCES.

D) ADJUST DISTANCES TO COMPLY WITH REQUIREMENT OF THE STATE OR LOCAL HIGHWAY AUTHORITY HAVING JURISDICTION. SEE NOTE 1. SHEET TC-

E) TAPER LENGTHS SHOWN BASED ON 12' LANE WIDTH.

DOT NOTES:

- WHEN LANE CLOSURE IS REQUIRED, THE TRAFFIC CONTROL PLAN SHOULD BE PROVIDED AND NOTARIZED BY AN INDIVIDUAL/COMPANY THAT HAS FLAGGER CONTROL TRAINING CERTIFICATION.
- "BLUE-LIGHTS" (OFF-DUTY POLICE OFFICERS) WILL BE ON SITE FOR LANE CLOSURES AND IF REQUIRED.



Verizon Wireless 2785 Mitchell Drive, Suite 9 Walnut Creek, CA 94598



Project Architect:



Site Agent:

100% Construction Drawings (E) LIGHT POLE

SF ALAMO 013

(NEAR) 184 CREEKDALE RD WALNUT CREEK, CA 94595

PSL #433679

Site Name:

Professional Seal:

It is a violation of law for any person, unless they are acting under the direction of a licensed Professional Architect/Engineer, to alter this document.

Rev.	Date	Description
01	07/08/17	Constr. Dwgs 90%
02	08/07/17	Constr. Dwgs 100%
03	10/05/17	Constr. Dwgs 100%
04	04/12/18	Constr. Dwgs 100%
05	06/04/18	Constr. Dwgs 100%

Project No.:

Date: 06/04/18 Job No.:

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Designed By: JG Checked: RB

SITE SPECIFIC VEHICLE TRAFFIC CONTROL PLAN

Meridian Management LLC, 2018



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