SF ALAMO 011



(NEAR) 401 HORSETRAIL CT ALAMO, CA 94507

PSL #433677 ORDER #31363291 RE PROJECT #20171517301 7012 AUG 13 PH 2: 02 WA18-0002

verizon/

Verizon Wireless 2785 Mitchell Drive, Suite 9 Walnut Creek, CA 94598

Project Architect:



100% Construction Drawings

Drawing Phase:

SF ALAMO 011 (NEAR) 401 HORSETRAIL CT ALAMO, CA 94507

Site Name:

Professional Seal:

It is a violation of law for any person, unless they are acting under the direction of a licensed Professional Architect/Engineer, to after this document.

01 03/01/16 Constr. Dwgs 90% 02 03/12/16 Constr. Dwgs 100% 03 04/03/16 Constr. Dwgs 100% 04 08/13/18 Constr. Dwgs 100% Project No.:

Rev. Date Description

Date: 08/13/18 Job No.: Scale: AS SHOWN CAD File: Designed By: IG Checked: RB

TITLE SHEET

Sheet Title

SITE INFORMATION

PSL #: OWNER: 433477

PG&E CALIFORNIA JOINT POLE 870 N. MCCARTHY BLVD. SUITE 110 MILPITAS, CA 95035 TEL (408) 635-8775

APPLICANT

2785 MITCHELL DRIVE, SUITE 9 WALNUT CREEK, CA 94598

AGENT:

ON AIR LLC 465 FIRST ST, WEST SUITE 101 SONOMA, CA 95476 TEL (707) 933-9633


APN ADJACENCY: SITE ADDRESS:

(IFO) 188-252-021 (NEAR) 401 HORSETRAIL CT. ALAMO, CA 94507

COUNTY:

CONTRA COSTA COUNTY

ZONING JURISDICTION: CONTRA COSTA COUNTY

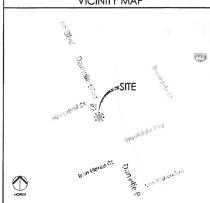

DRIVING DIRECTIONS

CODE COMPLIANCE CONSTRUCTION WORKS AND MATERIALS MUST COMPLY WITH ALL APPLICABLE NATIONAL STATE, AND LOCAL CODES AS ADOPTED BY LOCAL JURISDICTION, INCLUDING BUT NOT LIMITED TO:

- CAIRONNA CODE OF REGUATIONS
 2014 CAURONNA CHARGANICAL
 2015 CAURONNA CHARGANICAL
 2015 CAURONNA CHARGANICAL
 2015 CAURONNA CHARGANICAL
 2016 CAURONNA RECOME
 2014 CAURONNA RECOME
 2014 CAURONNA CHARGANICAL
 2016 CAURONNA
 2016 CAURONN
- Head south-west on Mitchell Dr towards N Wiget Ln

DIRECTIONS FROM VERIZON WIRELESS RF MARKET OFFICE:

- Head south-west on Mitchell Dri Iowards N Wigel Ln
 Turn left on to Wigel Ln
 Mergen col 1-689 Kd turn right and becomes Hillside Ave
 Use the left 2 knest to turn left on to the Intentate 480 S stp road to San Jose
 Mergen cols 1-680
 Take set SA for S Main 31
 Turn sight also Kohla 31
 Continue on to Danville BMc
 Pole will be an Intentify!

HANDICAP REQUIREMENTS

FACILITY IS UNMANNED AND NOT FOR HUMAN HABITATION, HANDICAPPED ACCESS NOT REQUIRED IN ACCORDANCE WITH CALIFORNIA ADMINISTRATIVE STATE CODE PART 2, TITLE 24, CHAPTER 11 B, SECTION 11038.

USA NORTH 811

ADMINISTRATIVE REQUIREMENTS

CONTRACTOR SHALL VERIFY ALL PLANS & (E) DIMENSIONS & CONDITIONS ON CONTRACTOR SHALL WARRED ATELY NOTIFY THE ENGINEER IN WRITING OF ANY DISCREPANCIES BEFORE PROCEEDING WITH THE WORK OR BE RESPONSIBLE FOR SAME IF USING 11"X17" PLOT, DRAWINGS WILL BE HALF SCALE

VICINITY MAP

ON AIR, LLC ON AIR LLC 465 FIRST ST, WEST SUITE 101 SONOMA, CA 95476 PROJECT MGR: CHRIS FOWLER

MOBILE: (63/1) 888-0809 OFFICE: (707) 933,9633 EMAIL: cfowler@onairlic.

CONSTRUCTION MANAGER: MOHAMMAD A. BASEER

PROJECT TEAM

MOBILE: (510) 414.7075 FMAIL: mbsseedlonstrile.com

SITE ACQUISITION MGR: PETE HILLIARD

ARCHITECT/ENGINEER

PROJECT MANAGEP: RODNEY BARNES

VERIZON WIRELESS VERIZON WIRELESS 2785 MITCHELL DRIVE BUILDING 9 WALNUT CREEK, CA 94598 SHEET NO: T.1 TITLE SHEET C.1 SITE SURVEY SITE SURVEY C.2 OVERALL SITE PLAN A.2 POLE PLAN ENLARGEMENTS A.3 ELEVATIONS A.4 ELEVATIONS

SCOPE OF WORK

A.5 EQUIPMENT DETAILS A.6 EQUIPMENT DETAILS

A 7 EQUIPMENT DETAILS E.1 SINGLE LINE DIAGRAM, BUSS DIAGRAM, PANEL SCHEDULE

F 2 POLE GROUNDING, ELECTRICAL DETAILS TC.1

SITE SPECIFIC VEHICLE TRAFFIC CONTROL PLAN

PROJECT DESCRIPTION

THIS IS AN UNMANNED TELECOMMUNICATIONS FACILITY FOR THE VERIZON WIRELESS NETWORK CONSTRING OF THE INSTALLATION AND OPERATION OF AN ANTENNA AND ASSOCIATED EQUIPMENT ON AN EXISTING WOOD POLE IN THE PUBLIC RIGHT-OF-WAY.

IN INSTALL NEW TELECOMMUNICATIONS EQUIPMENT SOME ON AN EXSTING 42.4 HT. POSE WOOD POLE.

OCLAMOUNTED EQUIPMENT TO BE INSTALLED ON A COP'S COMPLIANT STANDOFF BRACKET.


COMPLIENT CONSISTS OF 11,4 HT. CANTENIA, ON POLE TOP DITENSION, 129 RRISKS 2 AND (2) DIRECTED RISKS 2 END (2) DIRECTED RISKS 2 AND (2) DIRECTED RISKS 2 SHOULD FREE REPROMADE ON, ID SECONICET SHYRICS, 21 THE OLLANDS, AND (1) POLEMOUNTED POWER METER.


SHOULD FEEL SEPT AS REQUIRED VALSFAR DEEP BARTH COLOR


A WORLD FOUR FROM OVERHELD POL.


FORMER SERVICE RISMO VERHELD POL.


DRAWING INDEX

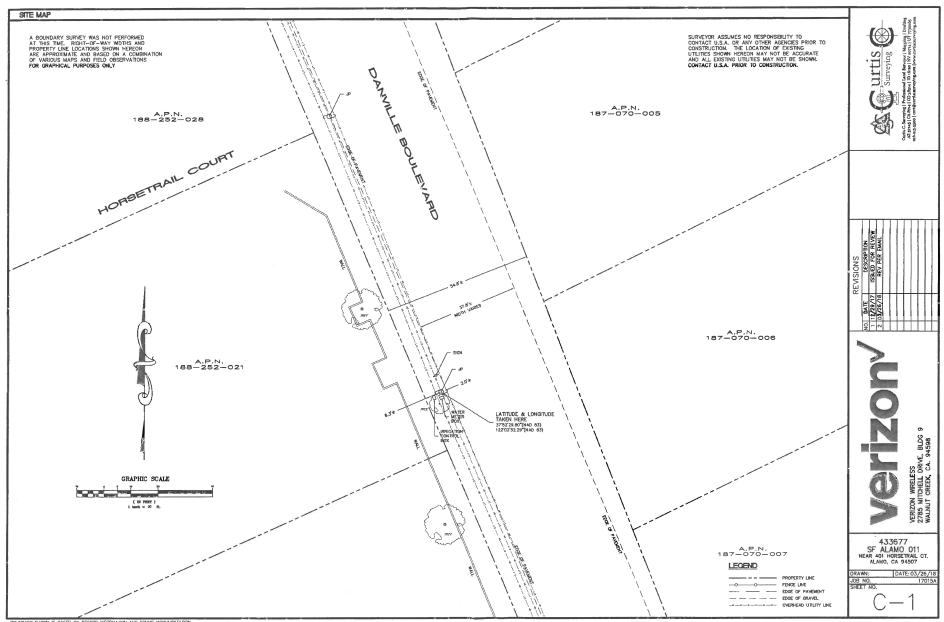


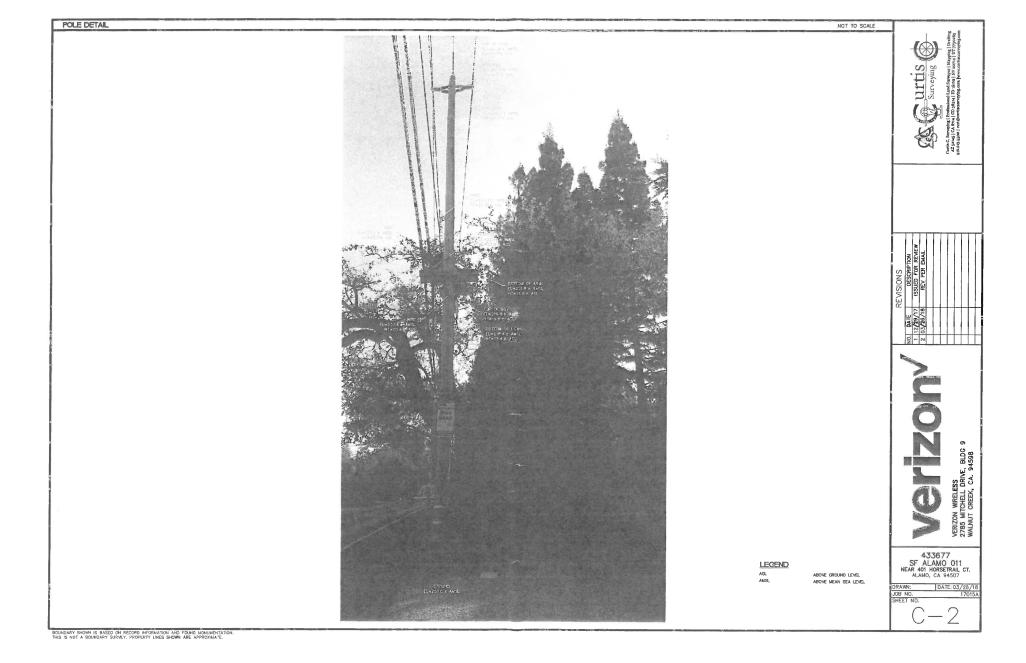


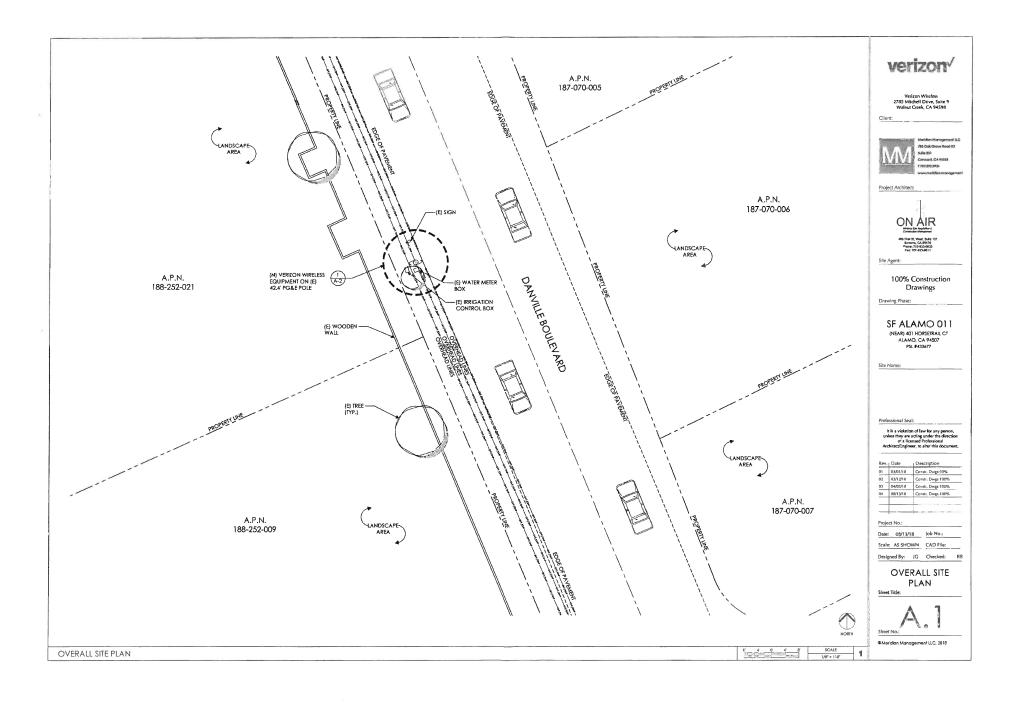


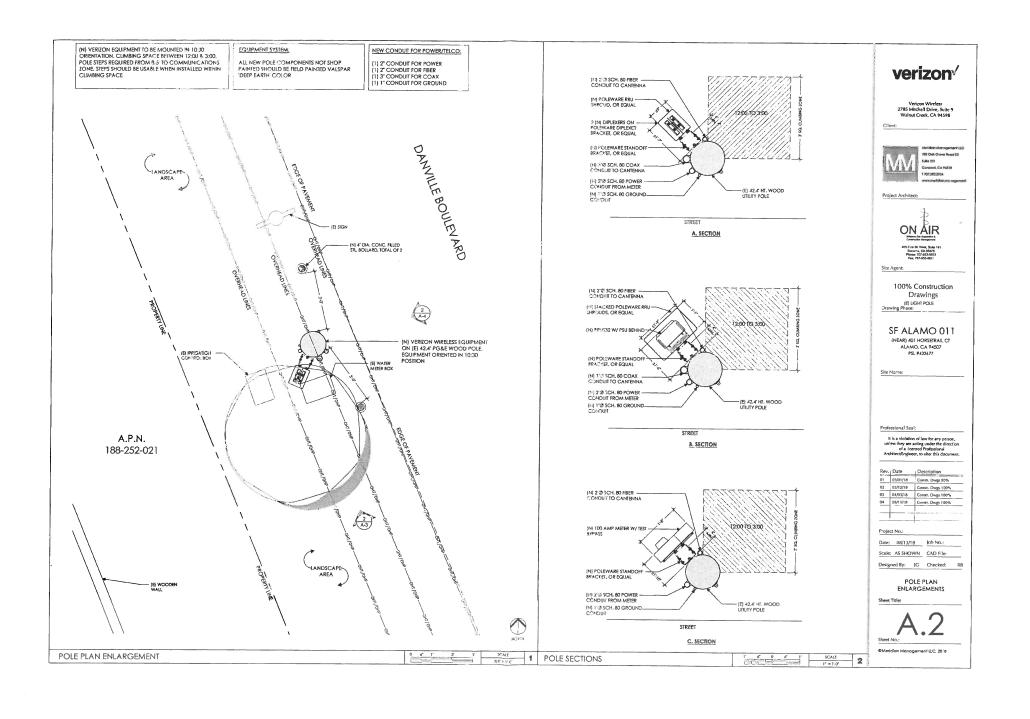

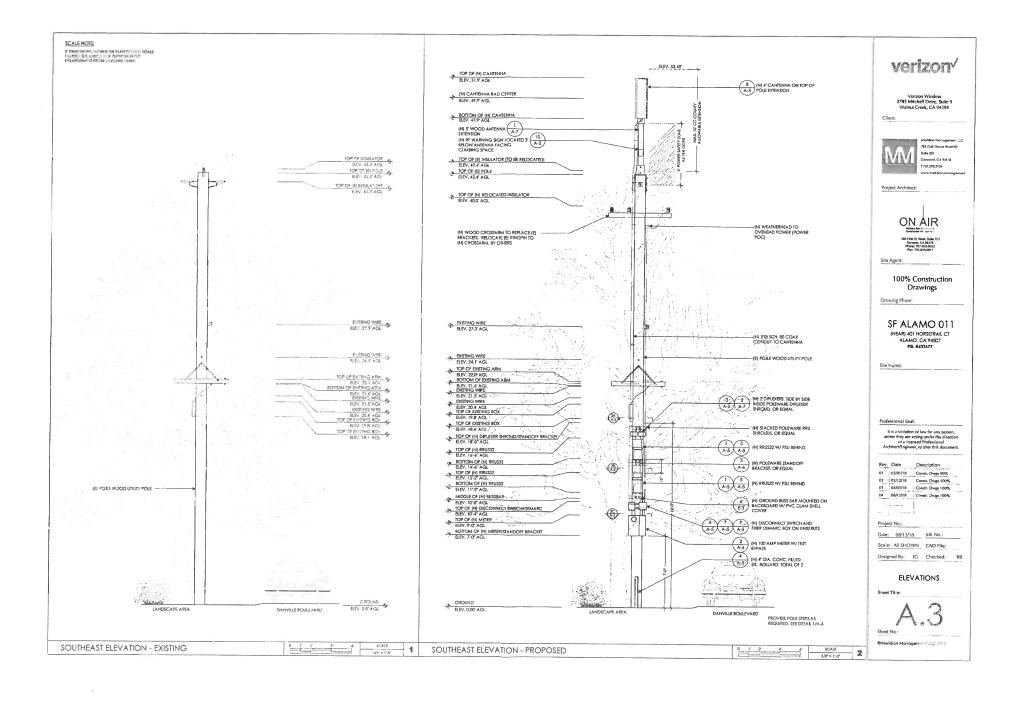

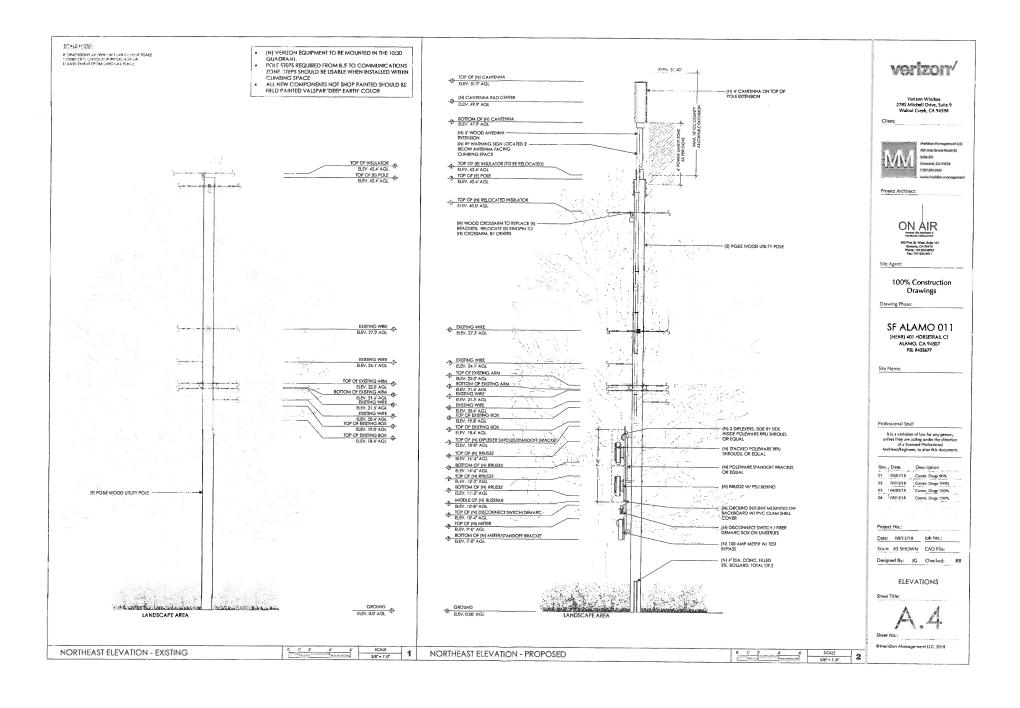

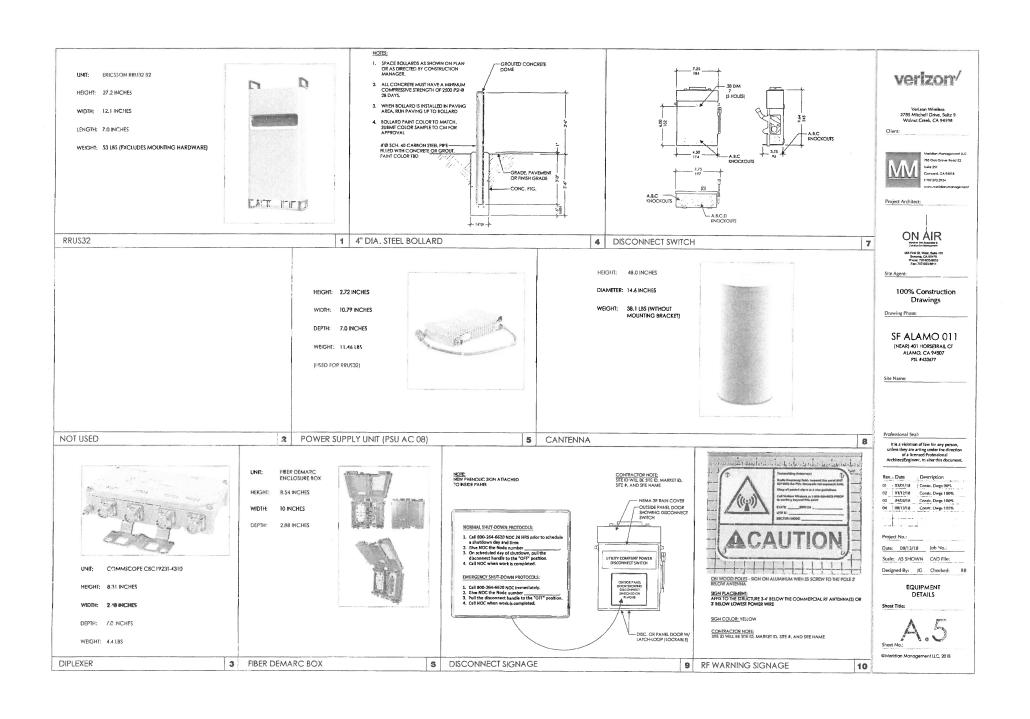

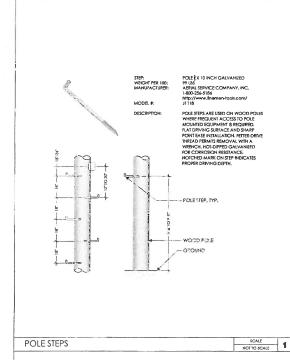

100 AMP METER W/ TEST BYPASS HEIGHT: 24 INCHES


WIDTH: 25 INCHES

DEPTH: 4-5/8 INCHES



3"X3"X]" SQ, CURVED WASHED ON BACK OF POLE, TYP, OF 3 FIØ THRU BOLT W/ 3"X3"X}" SQ. — CURVED WASHED ON BACK OF POLE, TYP. OF 3 WOOD UTILITY POLE (BY -4" HT. NEOPRENE BEARING — PAD, TYPICAL AT EA. BRACKET POLEWARE ADJUSTABLE BRACKET, TYP. OF 3 POLEWARE STL. C CHANNEL P3300HS 12 GA, VERT, UNISTRUT-CHANNELS, BOTH SIDES OF STANDOFF BRACKET P3300HS HORIZ, UNISTRUT — CHANNELS FOR EQUIPMENT ATTACHMENT, BY OTHERS, CUT TO FIT, INSTALL W/ CHANNEL NUTS W/ SPRINGS.

STANDOFF BRACKET PLAN

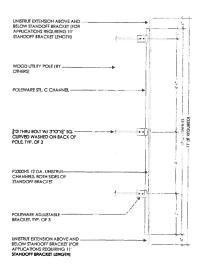


STANDOFF BRACKET SIDE ELEVATION


NOTE:

- STANDOFF BACKET MODE: 41** 1.20** 15". AD-32" AS MFG, BY POERWIRE LC (147) 31"-511") ORECULU.
 ALL COMPONENTS 10 85 SHOF PRIMED PAINTED.
 UNISTRUT COMPONENTS 10 85 BING BY UNISTRUT CORPORATION. 1140
 W.THORNDALE AVE. (1ASCA IL. 40)143, 800) 448-9510.
 HORIONAL MUNISTRUS (1900)65 FOR EQUIPMENT INSTALLATION NOT
- NCLUDED

 5. ADJUSTABLE BRACKETS FOR SLANTED POLES AVAILABLE BY SPECIAL ORDER

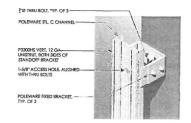

STANDOFF BRACKET BRACKET ISO

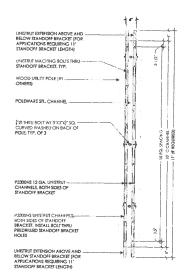

STANDOFF BRACKET FRONT ELEVATION



Verizon Wireless 2785 Mitchell Drive, Suite 9 Walnut Creek, CA 94598



786 Oak Grove Road E2 Suite 251 Concord, CA 94518 T 707,592,5924

Project Architect:



Site Agent:

100% Construction Drawings

SF ALAMO 011 (NEAR) 401 HORSETRAIL CT ALAMO, CA 94507 PSI. #433677

Site Name:

Professional Seal:

It is a violation of law for any person, unless they are acting under the direction of a licensed Professional Architect/Engineer, to alter this document.

Rev. Date Description 01 03/01/18 Constr. Dwgs 90% 02 03/12/18 Constr. Dwgs 100% 03 104/03/18 Constr. Dwgs 100% 04 08/13/18 Constr. Dwgs 100%


Project No.:


Date: 08/13/18 lob No.: Scale: AS SHOWN CAD File:

Designed By: JG Checked: RB

EQUIPMENT DETAILS

Sheet Title:

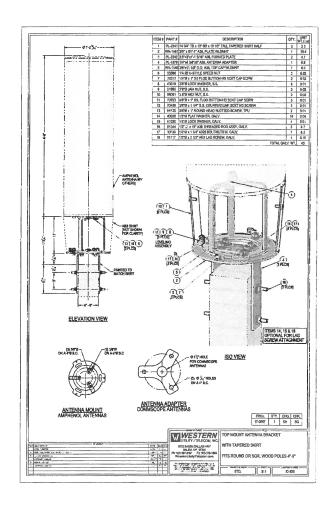

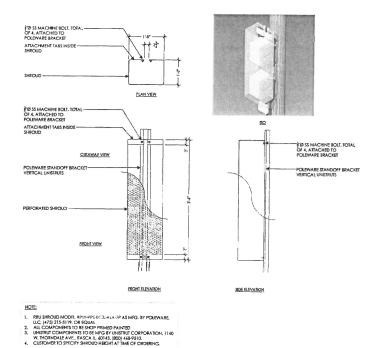

verizon/

Verizon Wireless 2785 Mitchell Drive, Suite 9 Walnut Creek, CA 94598



785 Oak Grove Road E2 Concerd, CA 94518

Project Architect:



Site Agent:

100% Construction Drawings

Drawing Phase:

SF ALAMO 011 (NEAR) 401 HORSETRAIL CT ALAMO, CA 94507 PSL #433677

Site Name;

It is a violation of law for any person, unless they are acting under the direction of a licensed Professional Architect/Engineer, to alter this document.

01	03/01/18	Constr. Dwgs 90%
02	03/12/18	Consts. Dwgs 100%
03	04/03/18	Constr. Dwgs 100%
04	08/13/18	Constr. Dwgs 100%


Date: 08/13/18 Job No.:

Scale: AS SHOWN CAD File:

Designed By: JG Checked: RB

EQUIPMENT

Sheet Title:

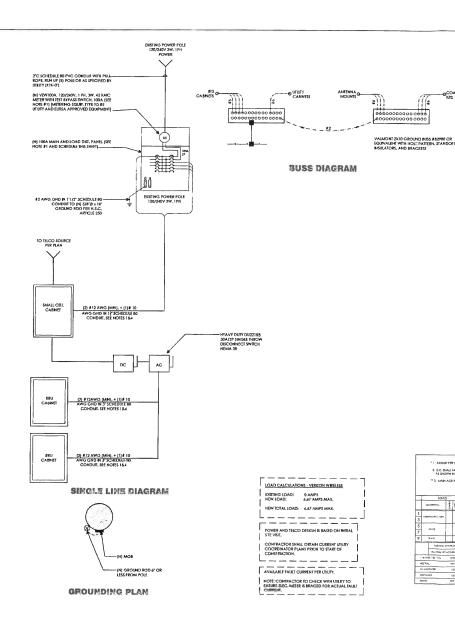

POWER AND TELCO NOTES:


- POWER AND TELCO POINTS OF CONNECTION AND ANY EASEMENTS ARE PRELIMINARY AND SUBJECT TO CHANGE BY THE UTILITY COMPANIES.
- 2. CONTRACTOR SHALL COORDINATE WITH UTILITY COMPANY FOR RINAL AND EXACT WORK/MATERIALS REQUIREMENTS AND CONSTRUCTTO UTILITY REQUIREMENTS AND SPECIFICATIONS ONLY WHERE A PPLICABLE PER PROJECT SCOPE OF WORK.
- CONTRACTOR SHALL FURNISH AND INSTALL CONDUIT, PULL WIRES, CABLE PULL BOXES, CONCRETE ENCASEMENT OF CONDUIT, TRANSFORMER PAD, BARRERS, POLE MISER IRENCHING, BACK FILL, AND UTILITY FEES, AND INCLUDE REQUIREMENTS IN SCORE.
- CONTRACTOR SHALL LABEL ALL MAIN DISCONNECT SWITCHES AS REQUIRED BY CODE.

NOTES:

- SUBCONTRACTOR SHALL PROVIDE METER WITH DIST. PANEL AND BREAKERS FOR POWER TO THE BTS UNITS AND THE BTS/UTILITY CABINET.
- ALL SERVICE EQUIPMENT AND INSTALLATIONS SHALL COMPLY WITH THE N.E.C. AND UTILITY COMPANY AND LOCAL CODE
- 3. SUBCONTRACTOR SHALL PROVIDE ELECTRICAL SERVICE ENTRANCE EQUIPMENT WITH FAULT CURRENT RATINGS GREATER THAN THE AVAILABLE FAULT CURRENT FROM THE POWER UTILITY.
- 4. FIELD ROUTE CONDUIT TO CABINETS AS REQUIRED.
- 5. MAXIMUM ONE WAY CIRCUIT RUN NOT TO EXCEED 75 FEET.

GENERAL ELECTRICAL NOTES:

- PROVIDE ALL ELECTRICAL WORK & MATERIALS AS SHOWN ON THE DWGS, AS CALLED FOR HEREIN, & AS IS NECESSARY TO FURNISH A
 COMPLETE INSTALLATION.
- 2. THE BITALLATION SMALL COMPORT TO THE REQUIREMENT OF THE CURRENT ADDITION OF LIGHTHAN EXCITACIAL CODE. THE OF CAMPORTMENT RILEAR ALL OTHER PREFICABLE CODE AND OPDIMANCES A THE REQUIREMENTS OF THE FRE MARKEDIAL ALL COMMENT & WIRING SMALL BEACH THE APPROVAL STAMP OF UNDERWINING LASORATORY (ALL OF AN APPROVED TESTING LASORATORY. ATMISTIC TO ALL BEFECTION FEES AND PERMISS ARE PLATED THE CONTRACT.
- 3. THE CONTRACTOR SHALL BE RESPONSIBLE FOR THE SHETY AND GOOD CONDITION OF ALL WATERLAS A COUPMENT FOR THE BITTER RISTLAND ON A UNIT COMPRETED OF WORK THE OF A WARTEN HAVE A SHEET A PROTECTIVE DEVICES A WATERLAS ASSOCIATED A SHEAR BEARDER, THOSE THE CHARGE WARTEN GO STORM AND CONTRACTIVE SHEAR THE PROCESSOR AND CORRECTIVED AND CONTRACTIVE SHEAR THE PROCESSOR AS WARTEN OR SHEAR THE SHEAR AND CONTRACTIVED AND CONTRACTIVE SHEAR THE PROCESSOR AS WARTEN OR SHE
- 4. COORDINATE THE ELECTRICAL INSTALLATION WITH ALL OTHER TRADES.
- 5. ALL SAW CUTTING, TRENCHING, BACK FILLING & PATCHING SHALL BE PART OF THIS CONTRACT.
- 6. PRIALEE ALL ELECTRICAL SERVICE ARRANGEMENTS, INCLUDING VERRICATION OF LOCATIONS, DETAILS, COORDINATION OF THE RISTALLATIONA FAYAMENT OF ACCIVIED CHARGES WITH LOCALE POWER COMPANY, VERRY LOCATION FOR FACILITIES & DETAILS WITH POWER UTILITY IN ADDITION TO THE RESIZEMENTS SCHOWN IN THE COMPRICATION WORK SHALL COMPLY WITH SCHOOL OF THE COMPRESS ASSENCE FOR COMPRISED SCHOOL THE PREPRICTIVE UTILITIES, INCLUDING ANY SUPPLEMENTAL DWGS SISUED & SHALL BE SIBLICET TO APPROVAL OF THESE UTILITIES.
- ALL WIRING SHALL BE COPPER. INSULATION FOR BRANCH CIRCUIT CONDUCTORS SHALL BE TYPE "THWN" CONDUCTORS LARGER AND
 #6 AWG MAY BE TYPE "THWN" OR TYYN".
- 8. PROVIDE CONDUIT SEALS FOR ALL CONDUITS PENETRATING WEATHERPROOFING OR WEATHERPROOF ENCLOSURE ENVELOPE, MASTIC SEAL ALL CONDUIT OPENING PENETRATIONS COMPLETELY WATERTIGHT.
- DALESS SHOWN OTHERWISE, FLISED DISCONNECT SWITCHES SHALL BE PROVIDED WITH LOW-PEAK, SLIDLAL BLEMENT RUSES SZED TO EXUMENDIT MANEPLATE LUSC CURRENT RATIOS, ACCIONS SHALL BE PROVIDED WITH SHALLARLY SZED TO RISBLE BLEMENTS. SWITCHES AND OTHER CONTROOT BECUMPACT SHALL BEAUTH SHALL SHALLONG BLUED LOTS HET PRIVINGHMENT.
- 10. THE CONTRACTOR SHALL BE RESPONSIBLE FOR TESTING THE GROUNDING SYSTEM AND ENSURING A 5 OHM OR LESS GROUNDING PATH, ADDITIONAL GOOLNON GRODS AND/ORK CHEMICAL IROD SYSTEM SHALL BE USED TO ACHIEVE THIS REQUIREMENT IF THE GYEN DESIGN CANNOT BE MADE! TO ACHIEVE THIS RECURREMENT.

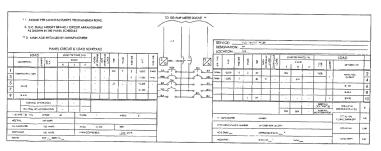

PANEL SCHEDULE -- PANEL " PP "

verizon/

Verizon Wireless 2785 Mitchell Drive, Suite 9 Walnut Creek, CA 94598

785 Oak Grove Road E2

Suite 251 Concord, CA 94518 1707.592.5924

Project Architect:



Site Agent:

100% Construction Drawings

Drawing Phase:

SF ALAMO 011 (NEAR) 401 HOPSETRAIL CT ALAMO, CA 94507 PSL #433677

Site Name:

Professional Seal:

It is a violation of law for any person, unless they are acting under the direction of a licensed Professional Architect/Engineer, to alter this document.


01	03/01/18	Constr. Dwgs 93%
02	03/12/18	Constr. Dwgs 190%
03	04/03/18	Constr. Dwgs 100%
04	38/13/16	Constr. Dwgs 100%

Project No.:

Date: 08/13/18 Job No.: Scale: AS SHOWN CAD File:

Designed By: JG Checked: RB

SINGLE LINE DIAGRAM PANEL SCHEDULE

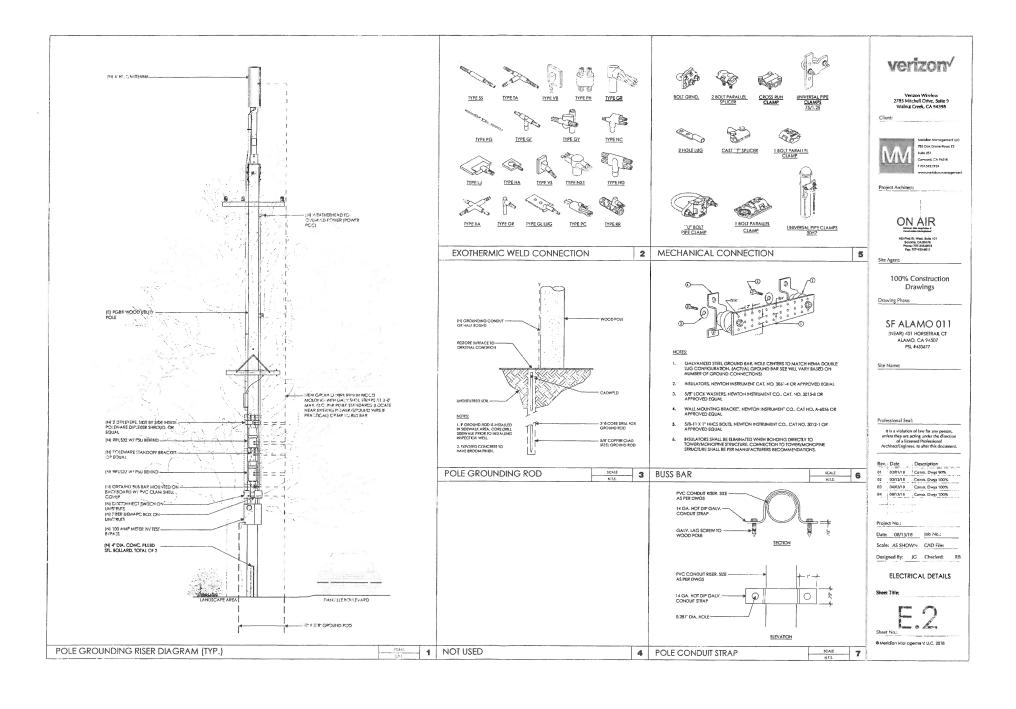

PLAN NOTES:

- P. PLANS DEPICIED ARE GENERAL GUIDELINES FOR TEMPORARY VENCULAR TRANSIC CONTROL PLANS (TOP) TO INCLIDE PROSERTIANI AND MOVERER SAFETY. CONTRACTOR IS REQUIRED TO HAVE PREPARED A SIE-SPECIFIC TOP FOR REVIEW AND APPROVAL BY THE HIGHWAY JUHNORITY HAVING JURISDICTION. IF REQUIRED, THE FIRM PREPARENG THE TOE SHALL BE AUTHORIZED OR CERTIFIED S'THE AUTHORITY HAVING JURISDICTION.
- 2. EXTEND CHANNELIZATION DEVICES INTO SHOULDER WHERE APPLICABLE.
- BITANCES AS INDICATES IN TABLE I SHOULD BE INCORASED FOR CONDITIONS HAT WOULD KERFET STOPPING, DISTANCES LICE AS DOWNGRADES OR BUNTED SIGHT DISTANCES, DISTANCES CAN BE DECREASED FOR LOW-SPEED (RESIDENTIAL) REARS WITH APPROVAL BY THE AUTHORITY HAVING JURISDICTION, INSIGHT, TIME WORK IS PROMISTED UNLESS IT IS REQUIRED AS A CONDITION OF APPROVAL BY THE HIGHWAY. LOCAL AUTHORITY HAVING JURISDICTION.
- 4. SHOULDER TAPERS SHOULD BE 1/3 OF THE ON-STREET TAPER LENGTH.
- 5. MAINTAIN A MINIMUM LANE WIDTH OF 10°.

LEGEND

CHANNELIZING DEVICE




SIGN



FLAGGER

C DIRECTION OF TRAFFIC

FLASHING ARROWSIGN (FAS)

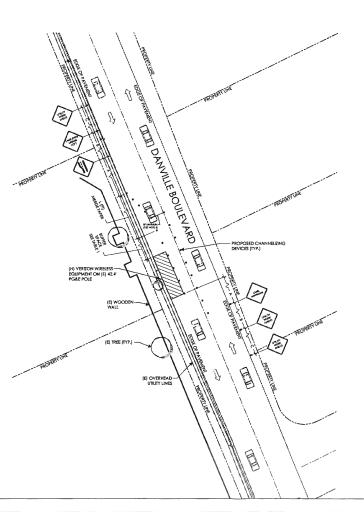

DOT NOTES:

- WHEN LANE CLOSURE IS REQUIRED, THE TRAFFIC CONTROL PLAN SHOULD BE PROVIDED AND NOTARIZED BY AN INDIVIDUAL/COMPANY THAT HAS FLAGGER CONTROL TRAINING CERTIFICATION.
- "BLUE-LIGHTS" (OFF-DUTY POLICE OFFICERS) WILL BE ON SITE FOR LANE CLOSURES AND IF REQUIRED.

verizon.

Verizon Wireless 2785 Mitchell Drive, Suite 9 Walnut Creek, CA 94598



785 Oak Grove Road E2 Suffe 251 Concerd, CA 94518

Project Architect:



Site Agent:

100% Construction Drawings (E) LIGHT POLE Drawing Phase:

SF ALAMO 011

(NEAR) 401 HORSETRAIL CT ALAMO, CA 94507 PSL #433677

Site Name:

It is a violation of law for any person, unless they are acting under the direction of a licensed Professional Architect/Engineer, to alter this document.

01	03/01/18	Constr. Dwgs 90%
02	03/12/18	Constr. Dwgs 100%
03	04/03/18	Constr. Dwgs 100%
04	06/13/18	Constr. Dwes 100%

Project No.:

Date: 08/13/18 Joh No.: Scale: AS SHOWN CAD File:

Designed By: JG Checked: RB

SITE SPECIFIC VEHICLE TRAFFIC CONTROL PLAN

Sheet Title:

			TABLE I		
POSTED SPEED (MPH)	DISTANCE BETWEEN SIGNS			TAPER	BUFFER
	A	В	С	L (SEE NOTE)	
15	100	100	100'	45	100
20	100'	100	100'	80'	115
25	100'	100	100"	125'	155
30	200'	200"	200'	180'	200
35	200'	200'	200'	245	250'
40	350'	3.50'	350'	320'	305
45	350'	350'	350'	540'	360'
50	500'	500'	500'	600'	425
55	500'	500'	500'	660'	495
60	500	500'	500'	7201	570
65	500	500"	500	780*	645
NOTEC:					

A) DISTANCES IN FEET UNLESS OTHERWISE NOTED.

B) CONTRACTOR TO VERIFY EXISTING SPEED LIMIT.

C) DISTANCES SHOWN ARE NOT VALID FOR LIMITED ACCESS HIGHWAYS. CONSULT STATE DOT MANUAL FOR DISTANCES.

D) ADJUST DISTANCES TO COMPLY WITH REQUIREMENT OF THE STATE OR LOCAL HIGHWAY AUTHORITY HAVING JURISDICTION, SEE NOTE 1, SHEET TO-2.

E) TAPER LENGTHS SHOWN BASED ON 12' LANE WIDTH.

NORTH

1

SCALE

OVERALL SITE PLAN